
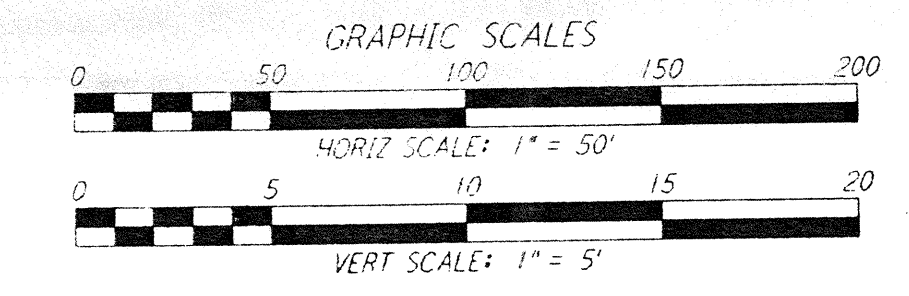
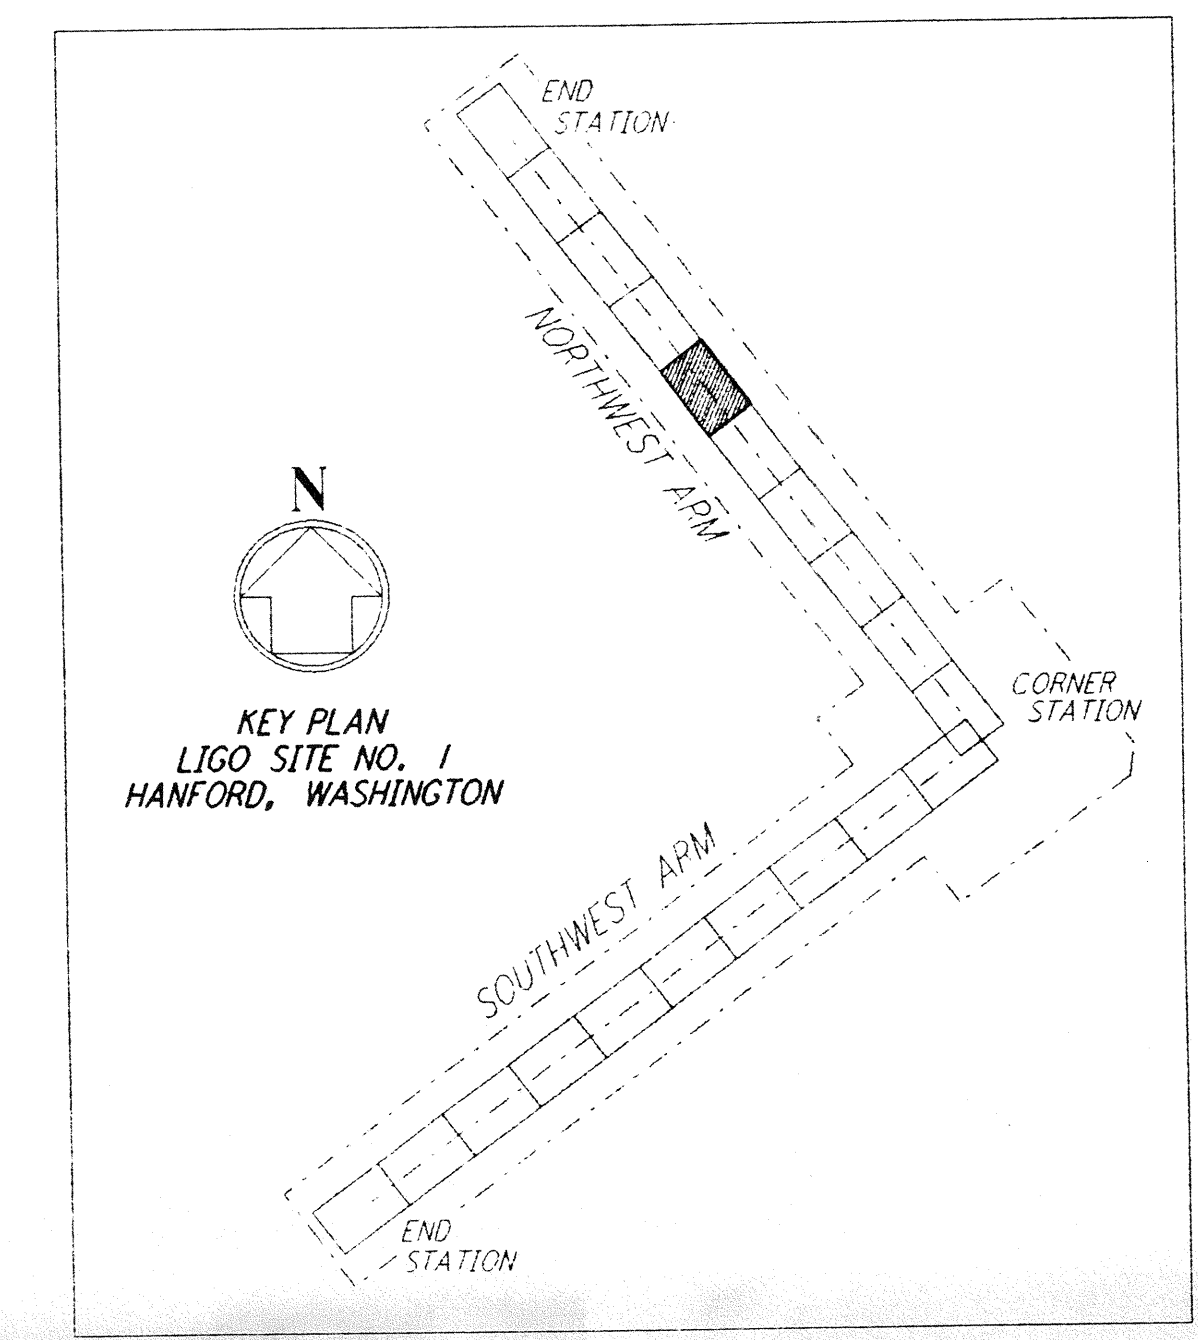
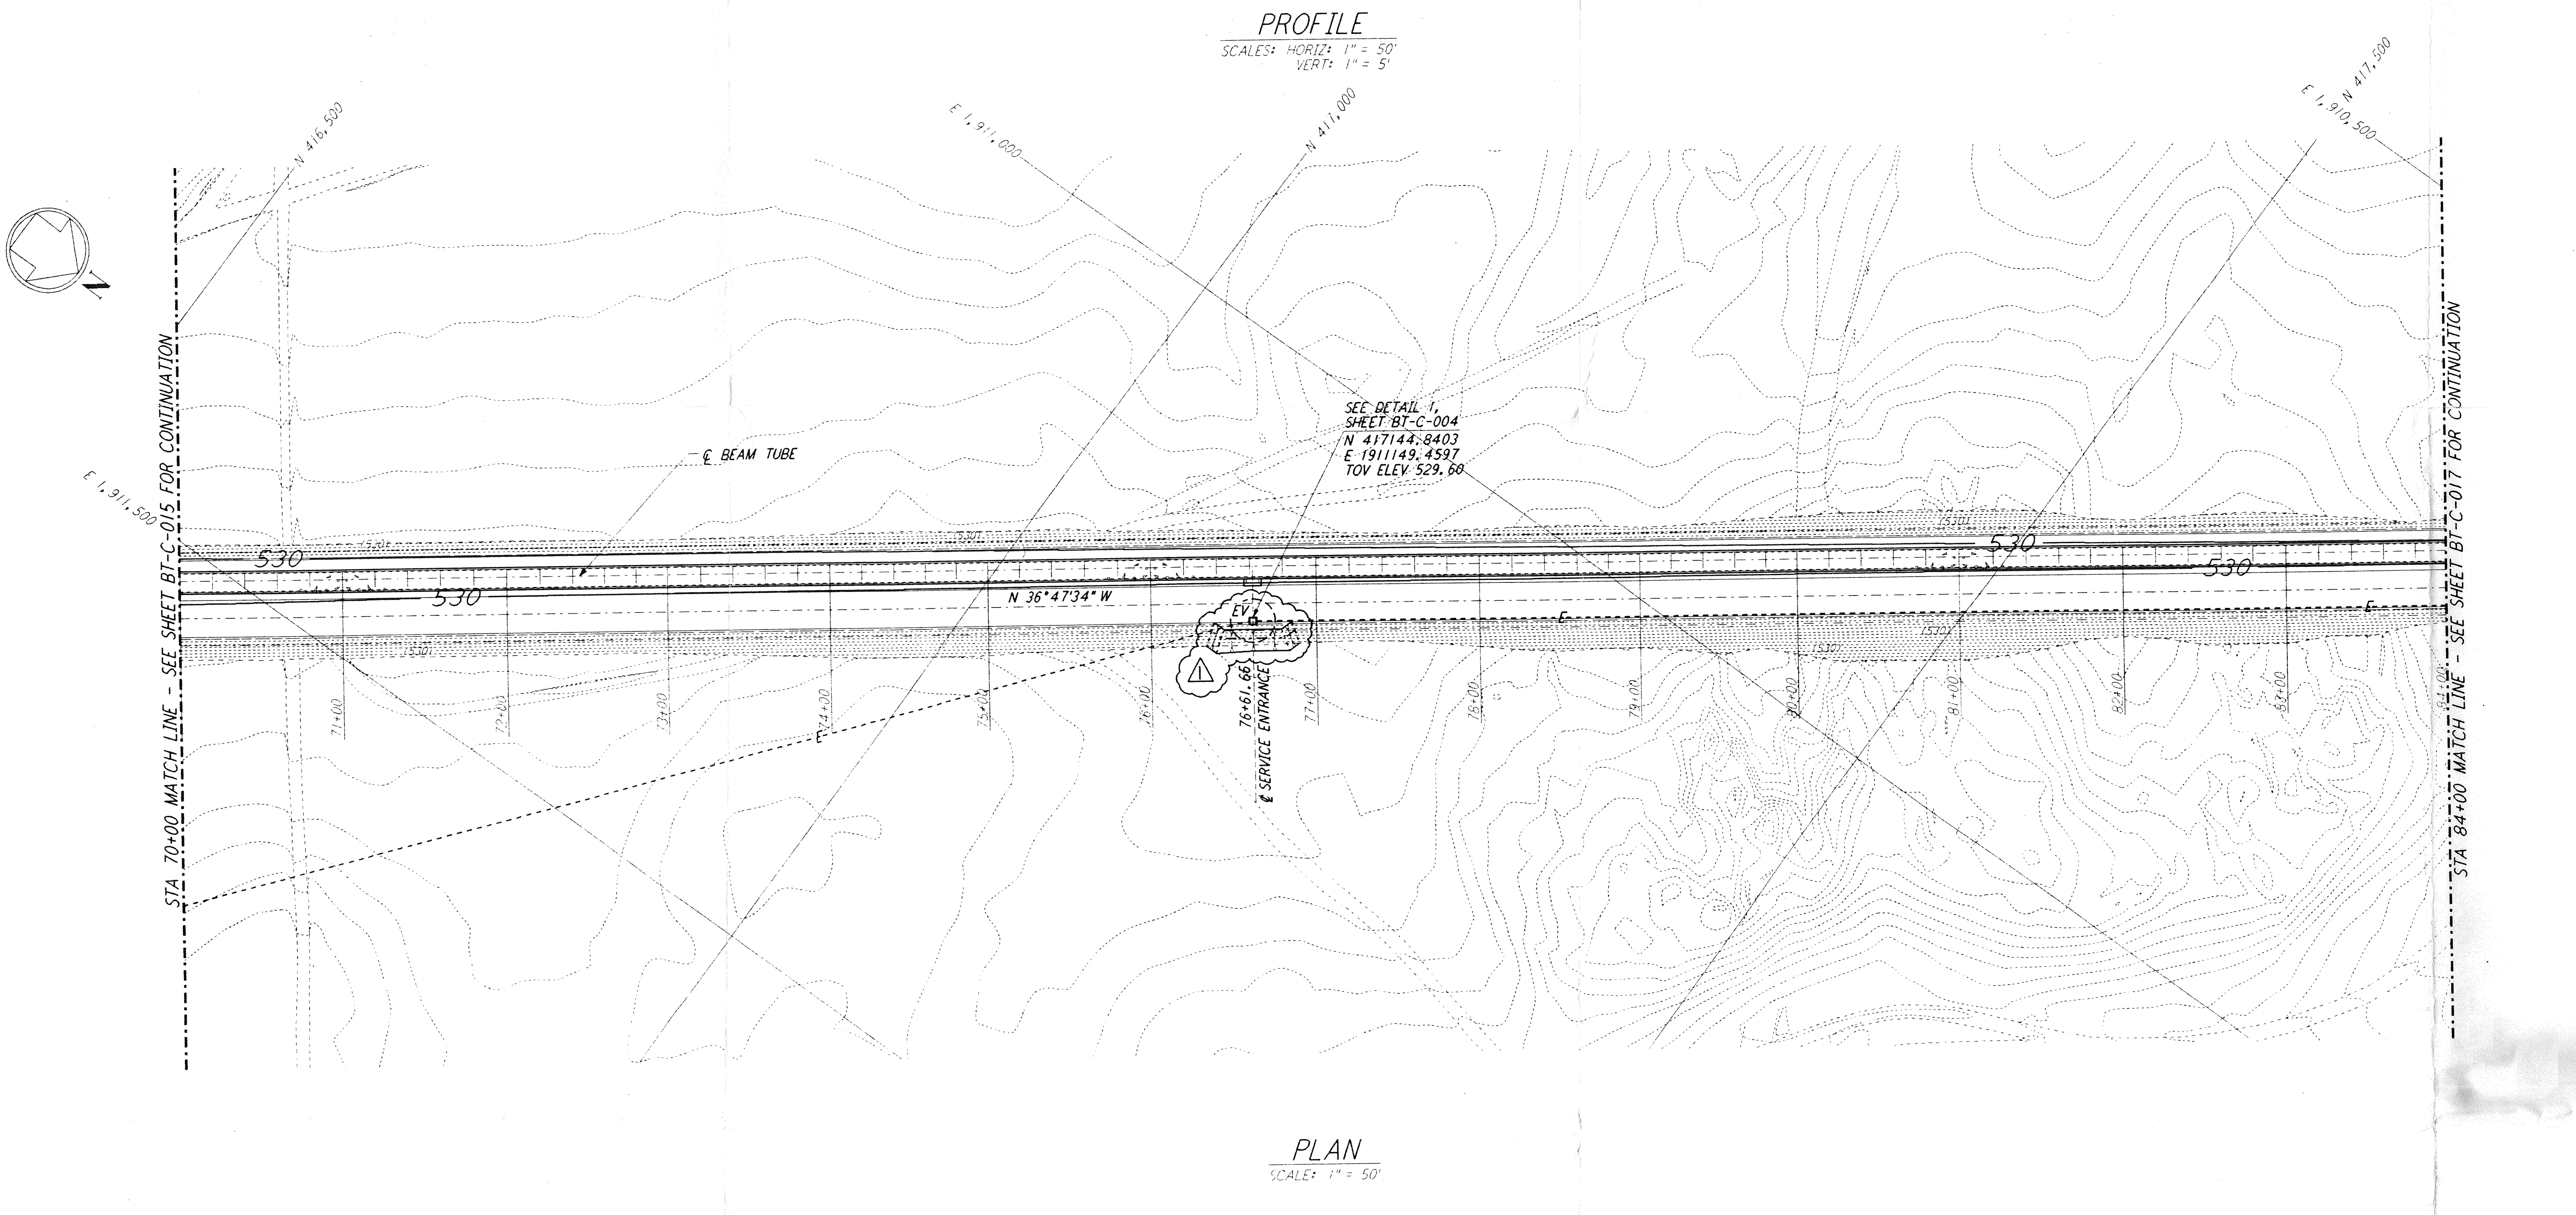


NOTES:
 1. SEE SHEET BT-C-002 FOR GENERAL NOTES, LEGEND AND ABBREVIATIONS.
 2. SEE SHEET BT-C-004 FOR TYPICAL SECTIONS AND DETAILS.

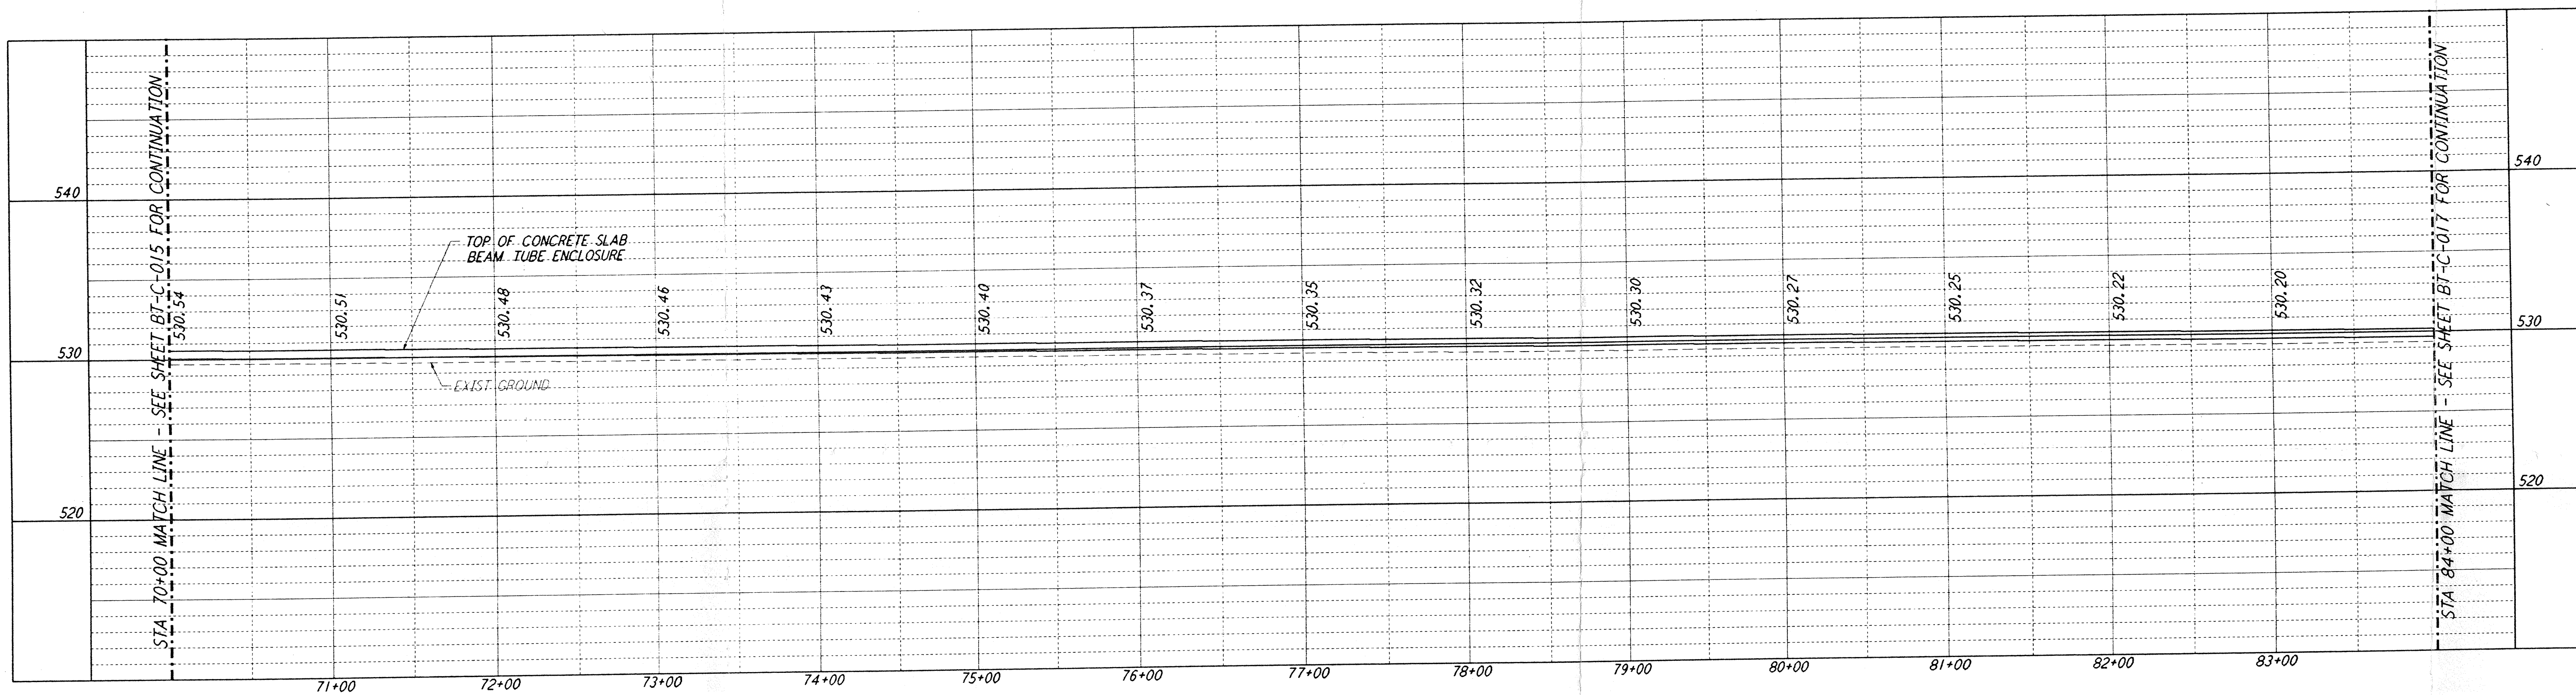

PROFILE
 SCALES: HORIZ: 1" = 50'
 VERT: 1" = 5'

PLAN
 SCALE: 1" = 50'

NO.	DATE	BY	CHKD	ENGR	PROJ	DESCRIPTION
1	2-29-96	WRB				CHANGE ORDER NO. 2

ISSUED FOR CONSTRUCTION	
DRAWN	WRB 1-19-96
CHECKED	MP 1-19-96
ENGINEER	JB 1-19-96
PROJ	MDW 1-19-96

John J. Adams
 n/96

PARSONS
 100 WEST WALNUT STREET
 PASADENA, CALIFORNIA

LIGO
 CALIFORNIA INSTITUTE OF TECHNOLOGY
 MASSACHUSETTS INSTITUTE OF TECHNOLOGY

LASER INTERFEROMETER
 GRAVITATIONAL-WAVE OBSERVATORY
 BTE SITWORK & FABRICATION - HANFORD, WA

TITLE: CIVIL NORTHWEST ARM PLAN AND PROFILE
 SHEET NUMBER: BT-C-016

AS NOTED PPI 50969 8094
 LIGO-D960171-01-D

DATE	3/25/96	LIGO	D960171-01-D
TITLE		CONTRACTOR	BT-C-016, Rev. 1
DATE		APPROVED	
DATE		APPROVED	
DATE		APPROVED	
DATE		APPROVED	

of PARSONS, they are deemed only with the
 borrower's expressed written agreement that they will
 PARSONS
 any other way, except by written consent
 to the borrower.

I:\ligo\site\lco\p016.dwg