
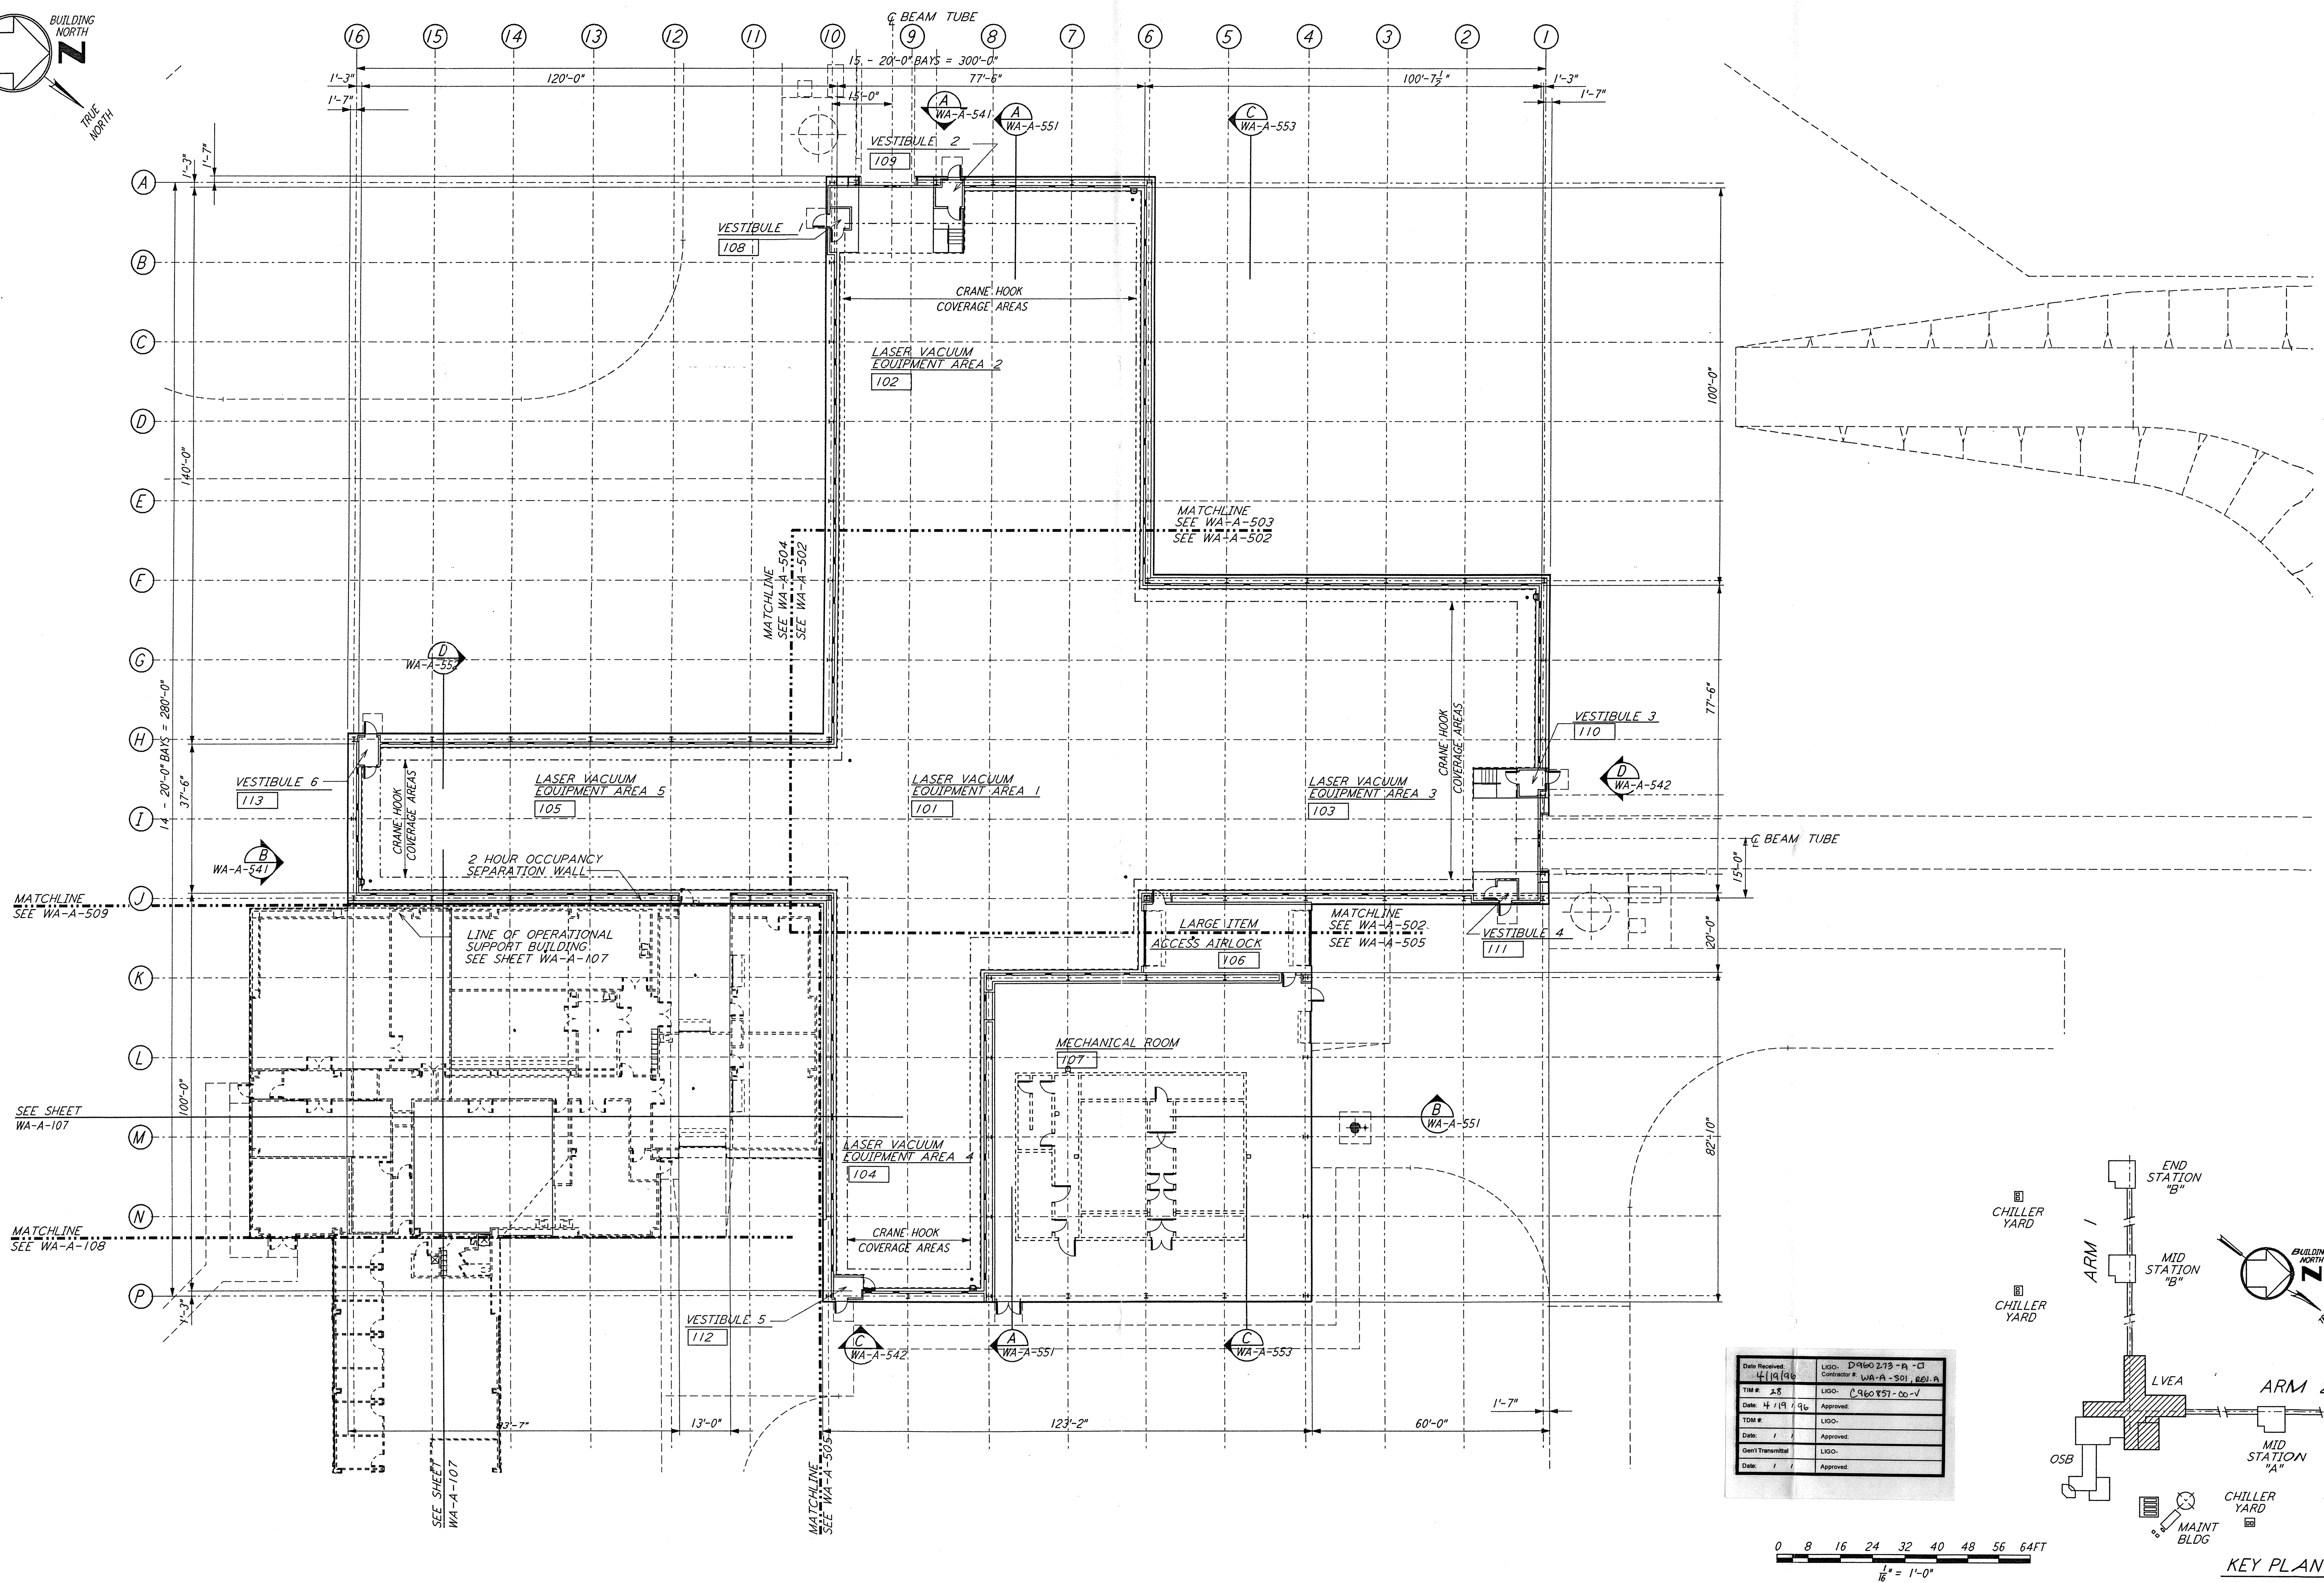
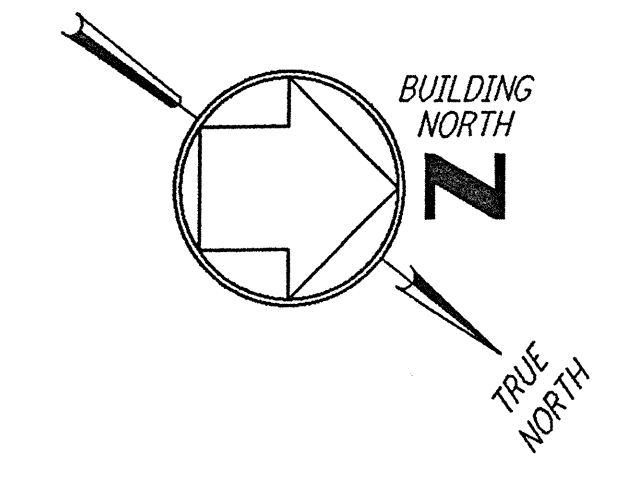
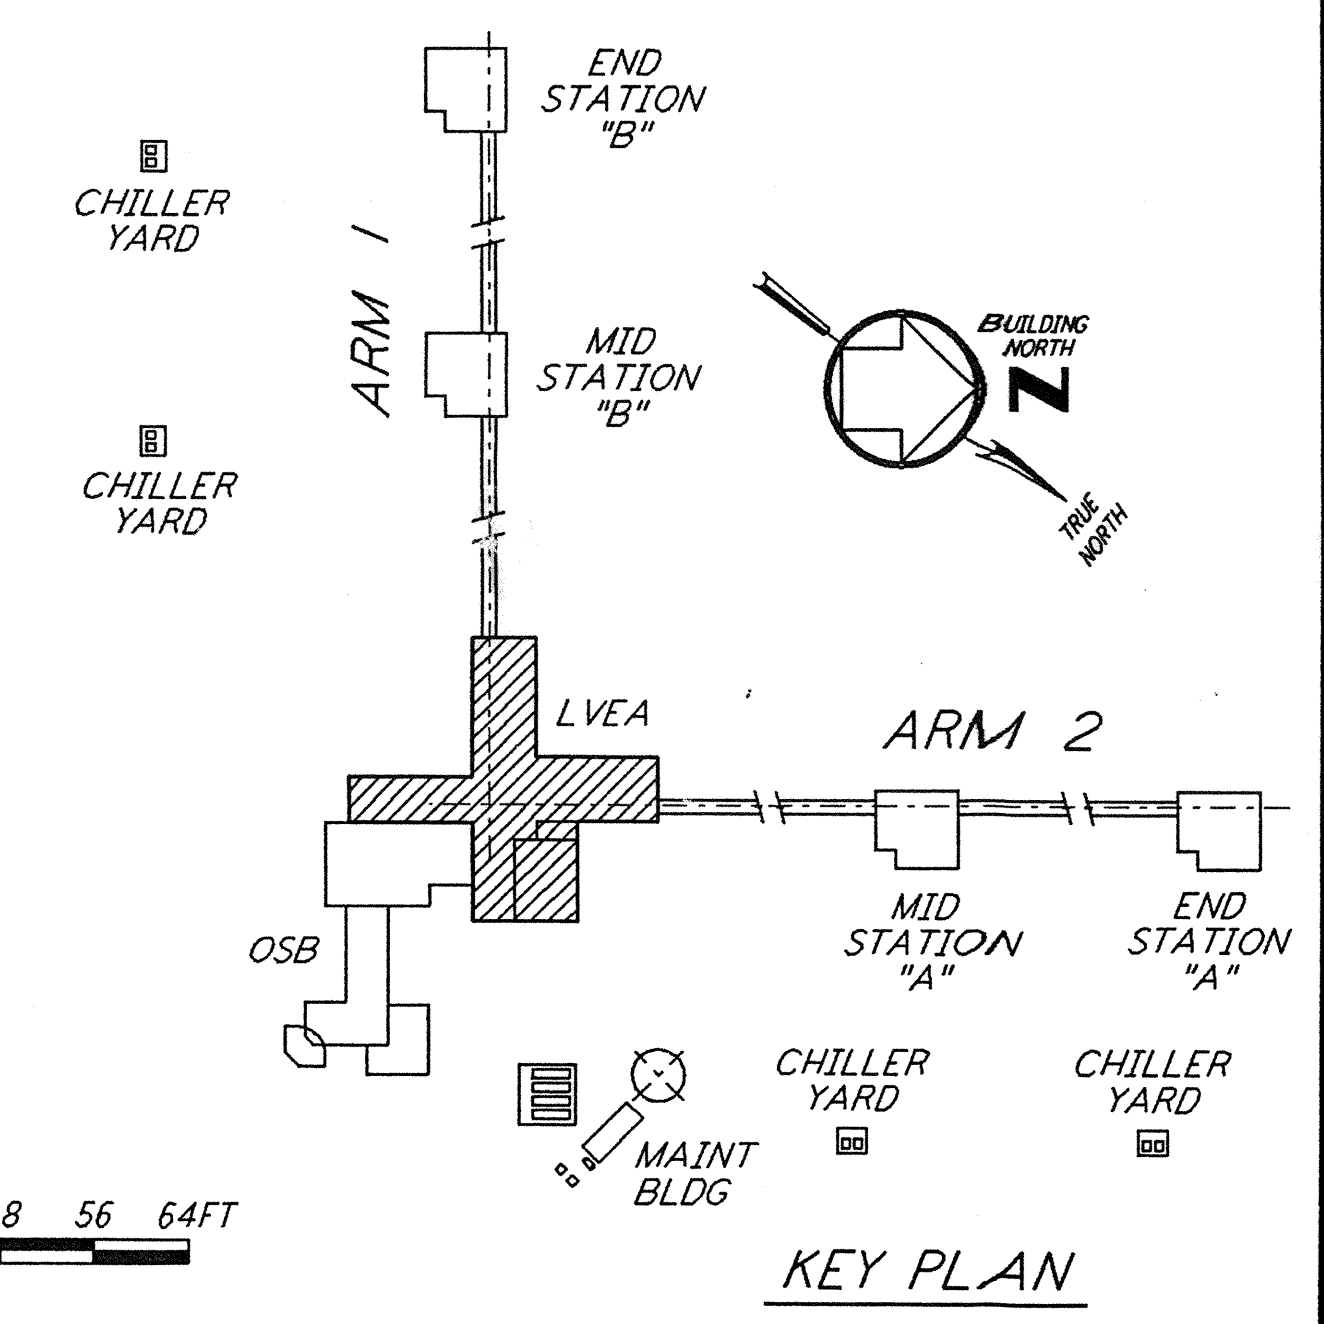


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Date Received: 4/19/96	LIGO: D-960273-A-CI
TR # 18	Contract: WA-A-501, 8094
Date: 4/19/96	Approved: C-960273-CO-V
TR # 1	LIGO:
Date: 1/1/96	Approved:
Client/Transmitted:	LIGO:
Date: 1/1/96	Approved:

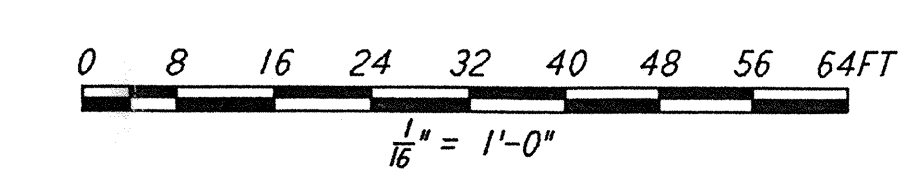

NO.	DATE	BY	CHKD	ENGR	PROJ	DESCRIPTION
A	4-19-96	SF	SFC	SDM		FINAL DESIGN REVIEW & BID

DRAWN	CKT/DS
CHECKED	
ENGINEER	
PROJ	

**PARSONS**  
 100 WEST WALNUT STREET  
 PASADENA, CALIFORNIA

**LIGO**  
 CALIFORNIA INSTITUTE OF TECHNOLOGY  
 MASSACHUSETTS INSTITUTE OF TECHNOLOGY

LASER INTERFEROMETER  
 GRAVITATIONAL-WAVE OBSERVATORY  
 SITE NO. 1 - HANFORD, WASHINGTON

TITLE: ARCHITECTURAL CORNER STATION LVEA FLOOR PLAN

SCALE: AS NOTED

CONTRACT NUMBER: PP150969

PROJECT NUMBER: 8094

SHEET NUMBER: WA-A-501

REVISIONS: A