
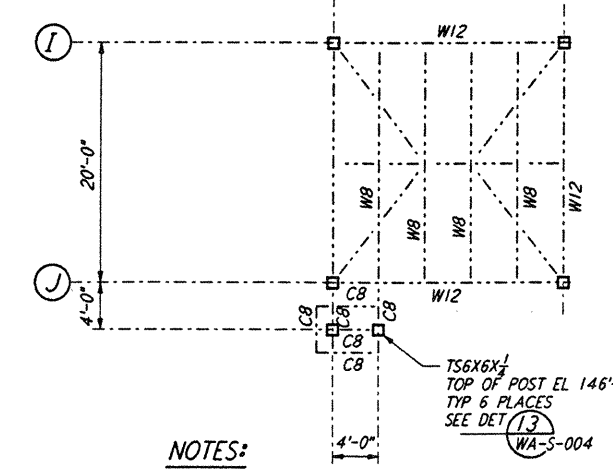




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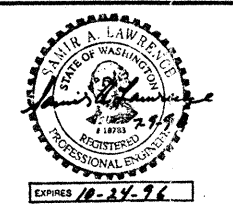
NOTES:
 1. PLATFORM SHALL BE DESIGN AND SUPPLIED BY CONTRACTOR. FOR INFORMATION NOT SHOWN SEE ARCHITECTURAL DWGS.
 2. FOR SUPPORT POSTS, SEE STRUCTURAL FRAMING ELEVATIONS.
ROOF PLATFORM SUPPORT PLAN
 $\frac{1}{8}'' = 1'-0''$

NOTES:
 1. FOR GENERAL NOTES SEE DRAWING WA-S-001.
 2. FOR BEAM TO BEAM CONNECTIONS, SEE DETAIL (3) TYP UON WA-S-005.
 3. FOR BEAM TO COLUMN CONNECTIONS, SEE DETAILS (6) & (4) TYP UON WA-S-004 & WA-S-007.
 4. FOR HORIZONTAL BRACING CONNECTIONS, SEE DETAILS (11), (12) & (13) WA-S-006, WA-S-006 & WA-S-006.
 5. AT INTERSECTION OF WTS BRACE, W12 BEAM AND W24 BEAM USE FULL DEPTH SHEAR PLATE FOR W12 AND W24 CONNECTIONS.

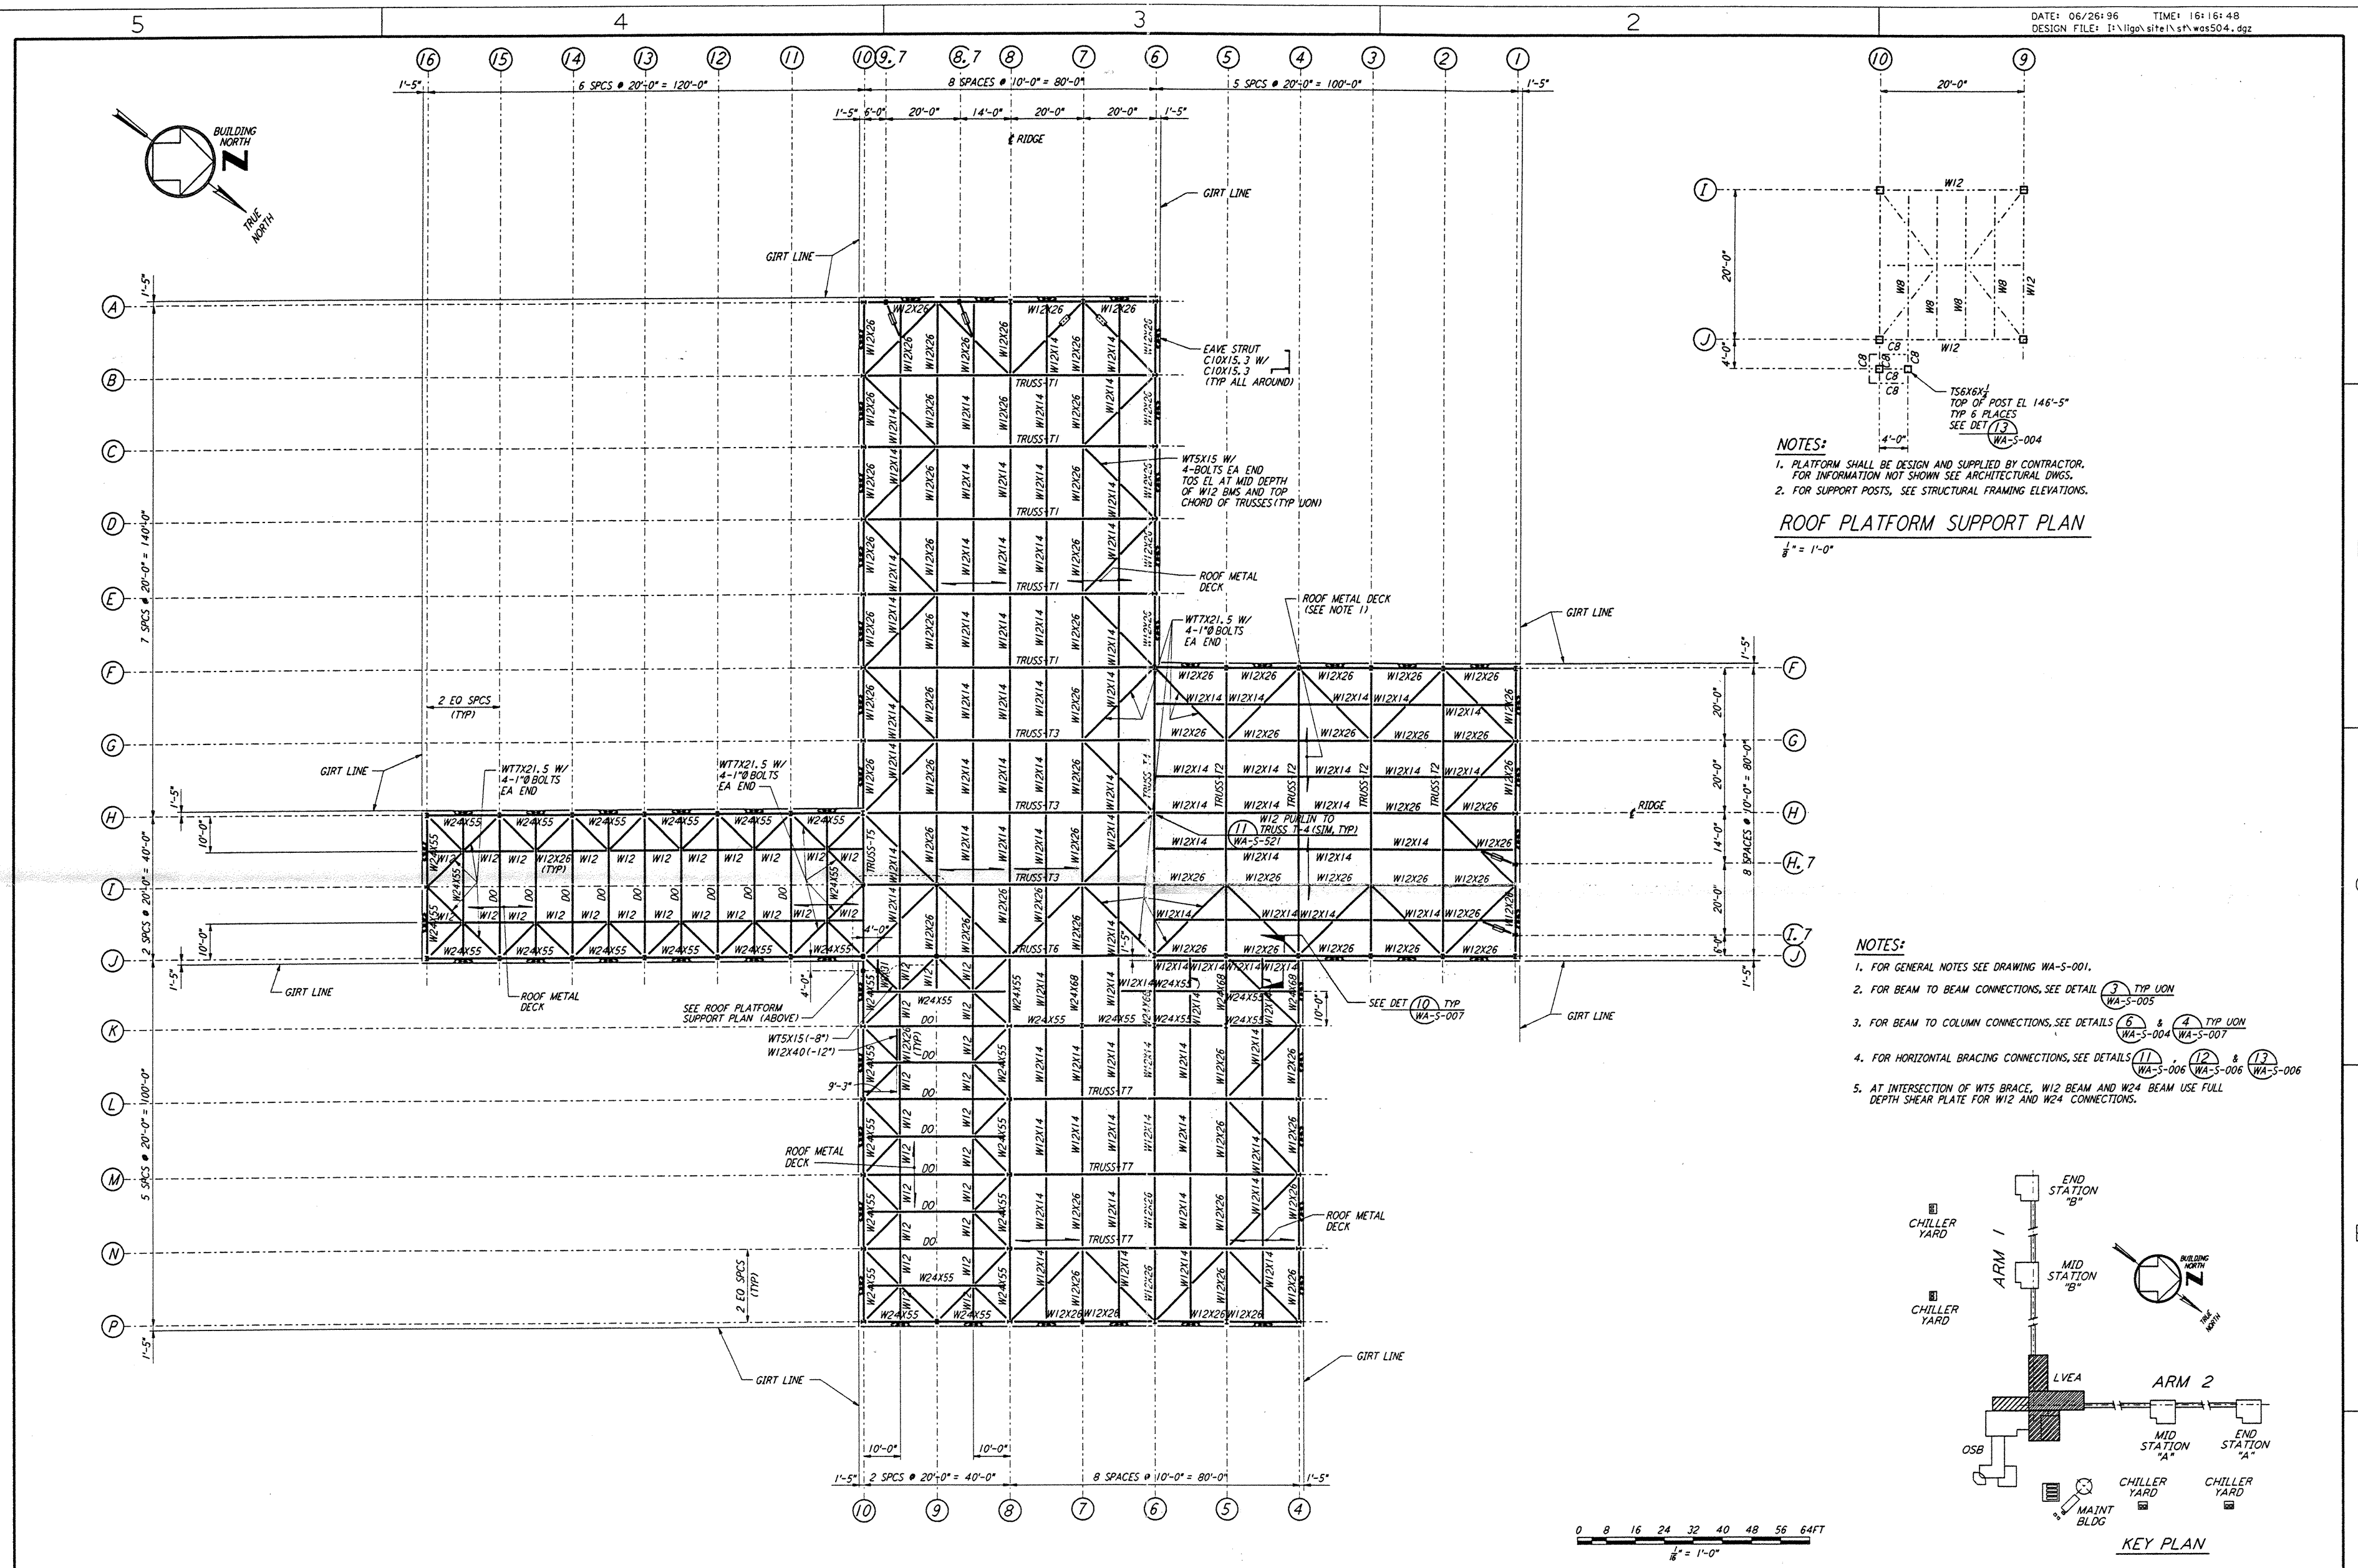

NO.	DATE	BY	CHKD	ENGR	PROJ	DESCRIPTION

ISSUED FOR CONSTRUCTION
 DRAWN MCS 6-24-96
 CHECKED EBN 7-5-96
 ENGINEER JH 6-28-96
 PROJ 11111 7-19-96

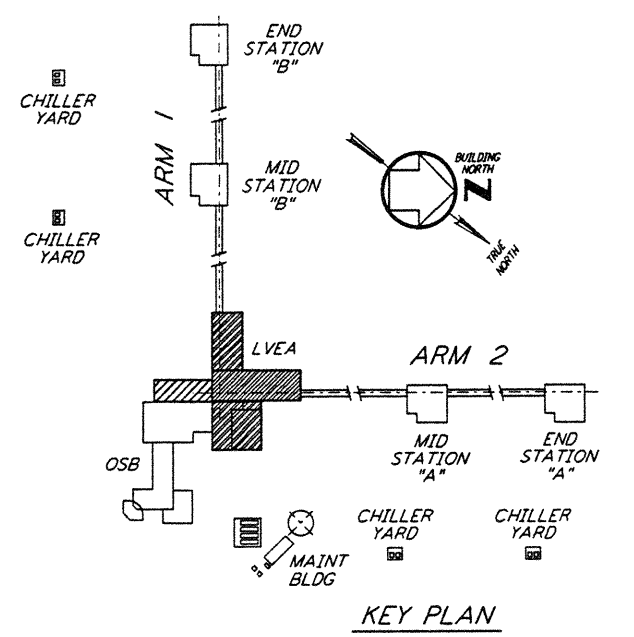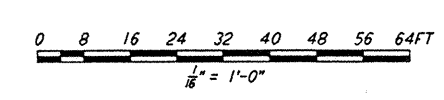

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 MASSACHUSETTS INSTITUTE OF TECHNOLOGY

LASER INTERFEROMETER
 GRAVITATIONAL-WAVE OBSERVATORY
 SITE NO. 1 - HANFORD, WASHINGTON

TITLE: STRUCTURAL CORNER STATION LVEA ROOF FRAMING PLAN
 SCALE: AS NOTED
 CONTRACT NUMBER: PP150969
 PROJECT NUMBER: 8094
 SHEET NUMBER: WA-S-504

LIGO-D960325-00-O | LIGOWAF.BOR