
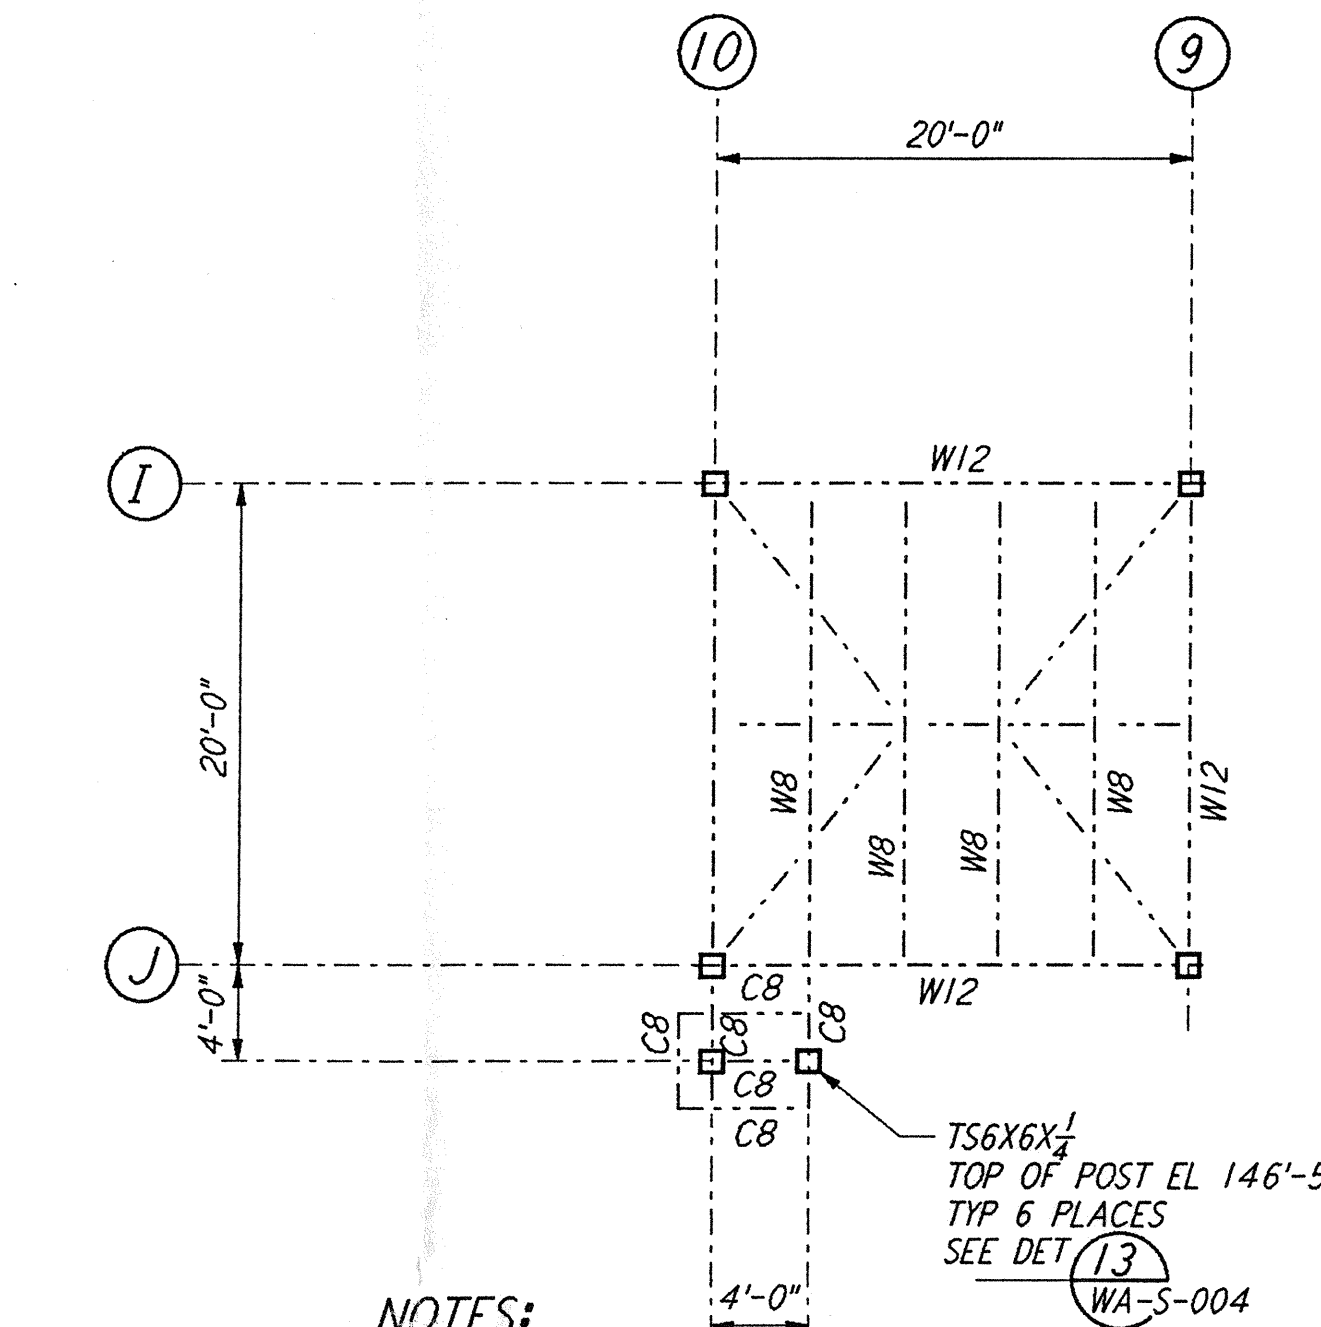




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NOTES:
 1. PLATFORM SHALL BE DESIGN AND SUPPLIED BY CONTRACTOR. FOR INFORMATION NOT SHOWN SEE ARCHITECTURAL DWGS.
 2. FOR SUPPORT POSTS, SEE STRUCTURAL FRAMING ELEVATIONS.
ROOF PLATFORM SUPPORT PLAN
 1/8" = 1'-0"

NOTES:
 1. FOR GENERAL NOTES SEE DRAWING WA-S-001.
 2. FOR BEAM TO BEAM CONNECTIONS, SEE DETAIL (3) TYP UON WA-S-005
 3. FOR BEAM TO COLUMN CONNECTIONS, SEE DETAILS (6) & (4) TYP UON WA-S-004 & WA-S-007
 4. FOR HORIZONTAL BRACING CONNECTIONS, SEE DETAILS (11) WA-S-006, (12) WA-S-006 & (13) WA-S-006
 5. AT INTERSECTION OF WTS BRACE, W12 BEAM AND W24 BEAM USE FULL DEPTH SHEAR PLATE FOR W12 AND W24 CONNECTIONS.

Date Received:	4-19-96	LIGO: D960325-A-B
Contract #:	WA-S-504 Rev. A	
Drawn:	4/19/96	LIGO: 1960857-00-1
Checked:		
Approved:		
Design Transmittal:		
Date:		

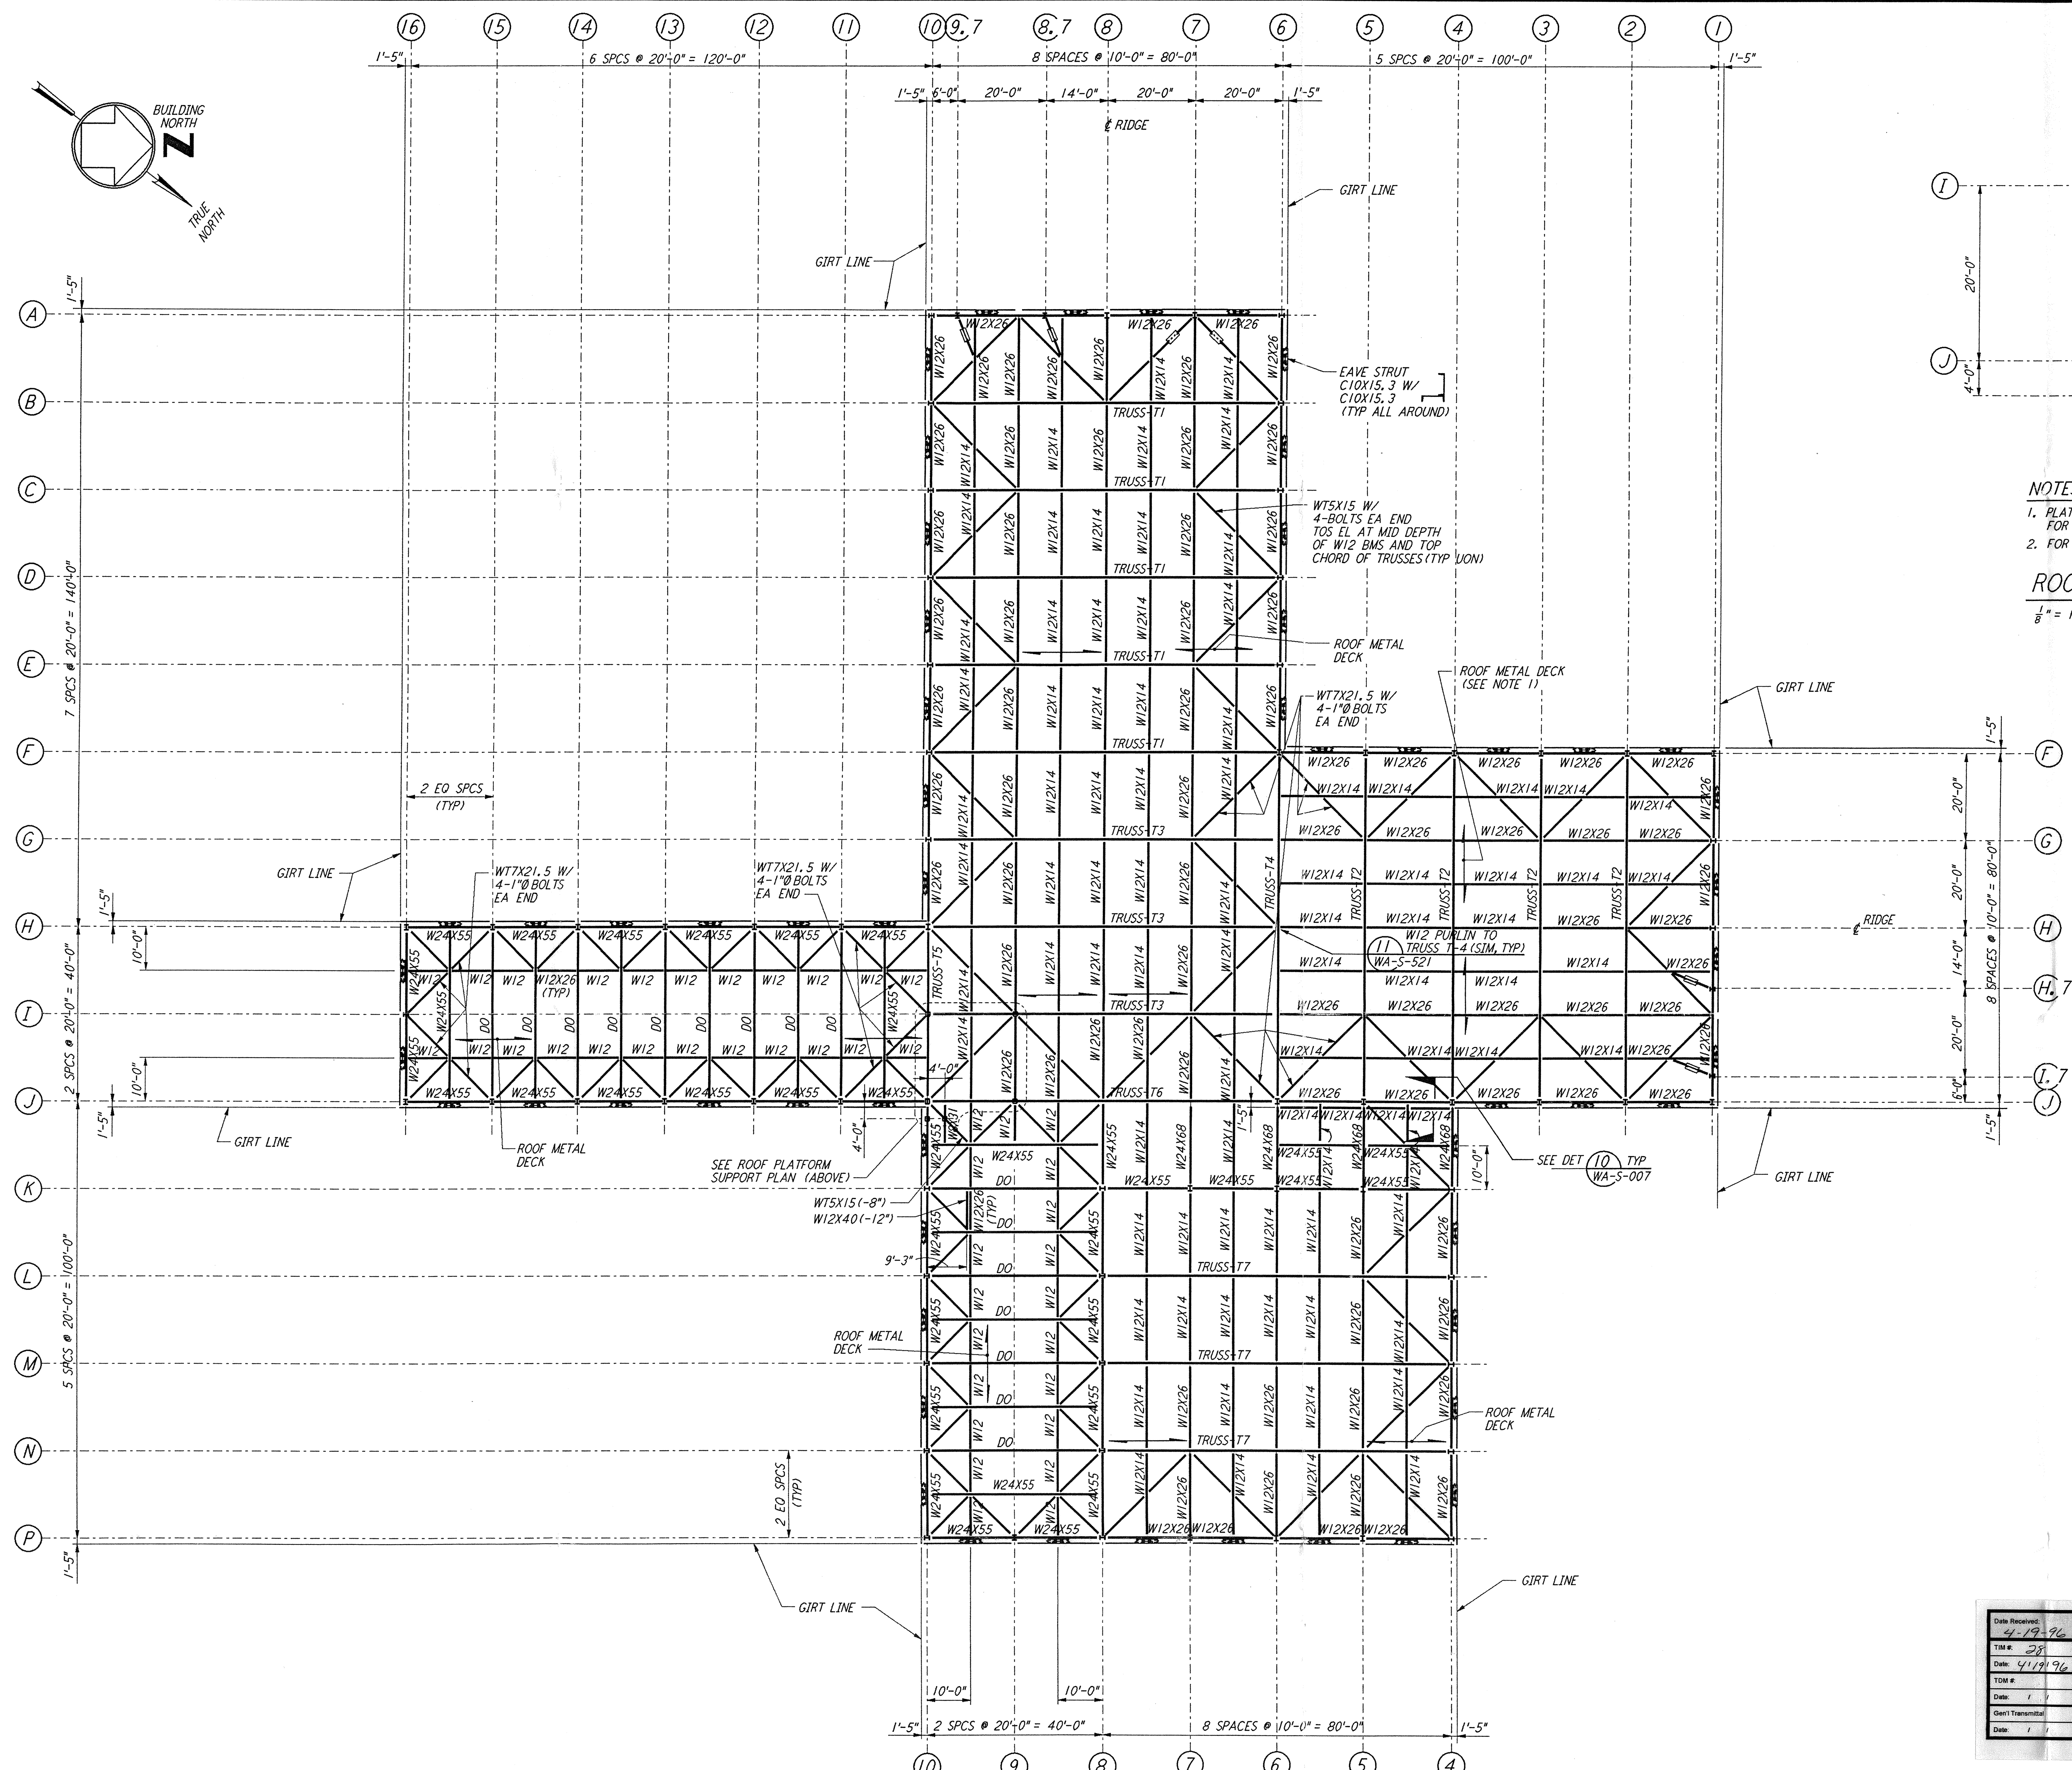

NO.	DATE	BY	CHKD	ENGR	PROJ	DESCRIPTION
A	4-19-96	MCS				FINAL DESIGN REVIEW & BID

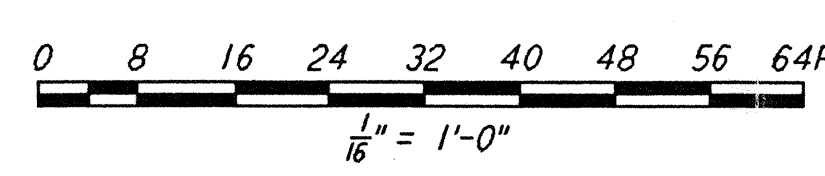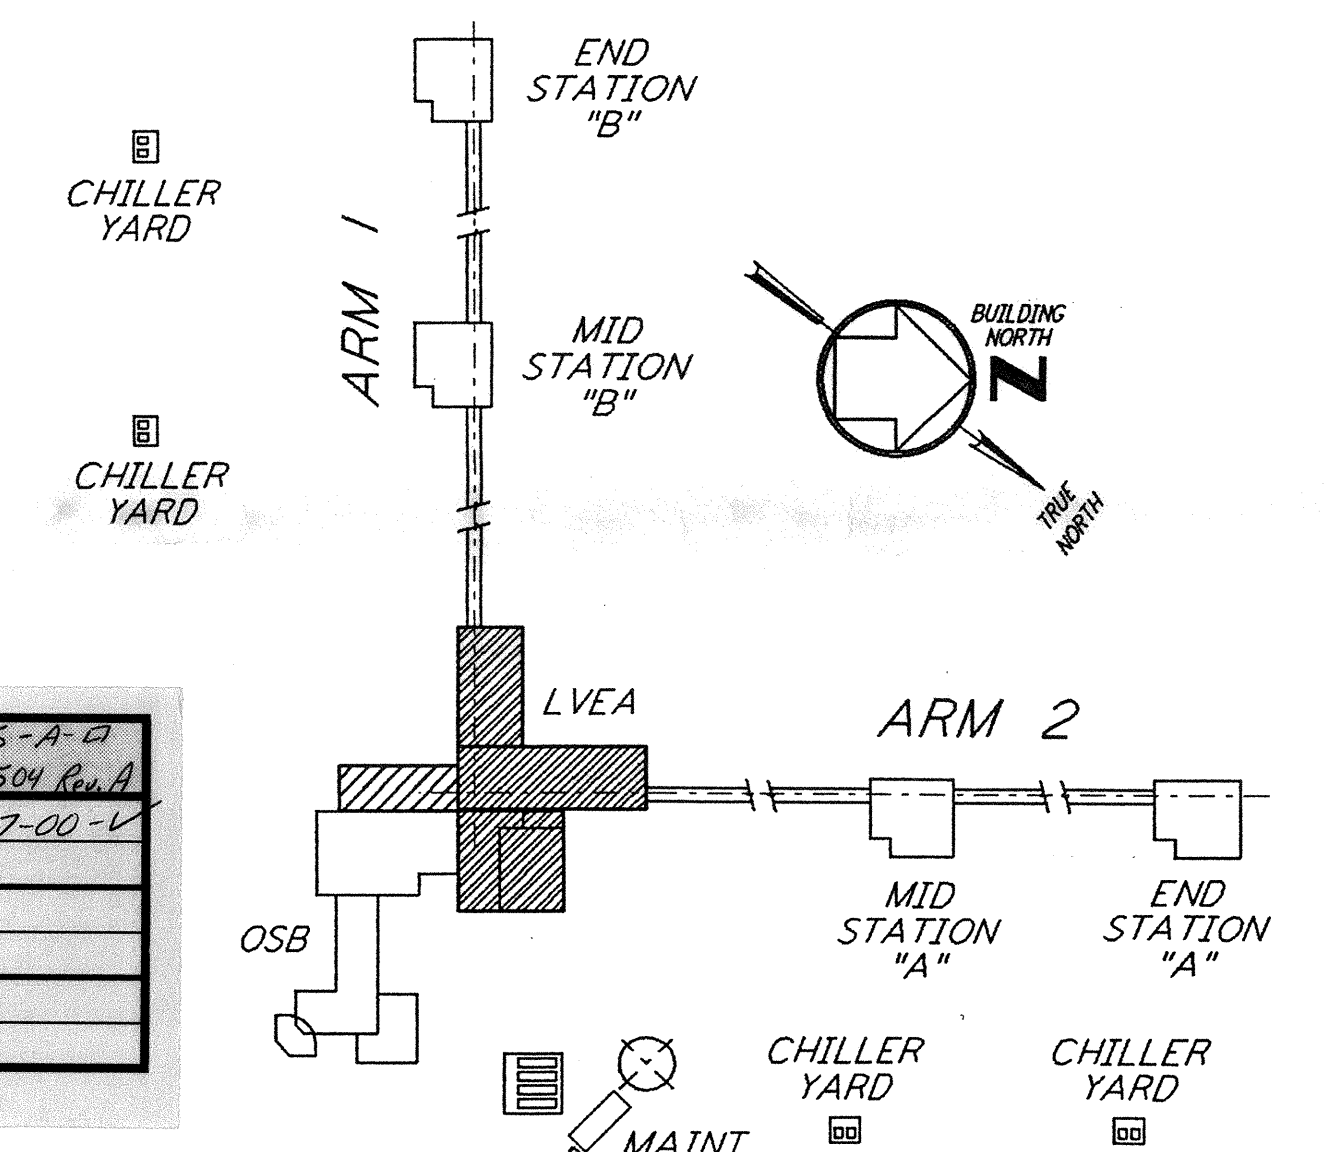DRAWN	MCS
CHECKED	
ENGINEER	
PROJ	

DATE	4-19-96
BY	MCS
CHKD	
ENGR	
PROJ	

PARSONS
 100 WEST WALNUT STREET
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 MASSACHUSETTS INSTITUTE OF TECHNOLOGY

LASER INTERFEROMETER
 GRAVITATIONAL-WAVE OBSERVATORY
 SITE NO. 1 - HANFORD, WASHINGTON

TITLE: **STRUCTURAL CORNER STATION LVEA ROOF FRAMING PLAN**

SCALE: AS NOTED

CONTRACT NUMBER: PP150969

PROJECT NUMBER: 8094

SHEET NUMBER: **WA-S-504**

REVISIONS: **A**

LIGO-D960325-A-B