



NOTES:

1. FOR LEGEND, ABBREVIATIONS AND GENERAL NOTES SEE SHEETS WA-H-001 AND WA-H-002.

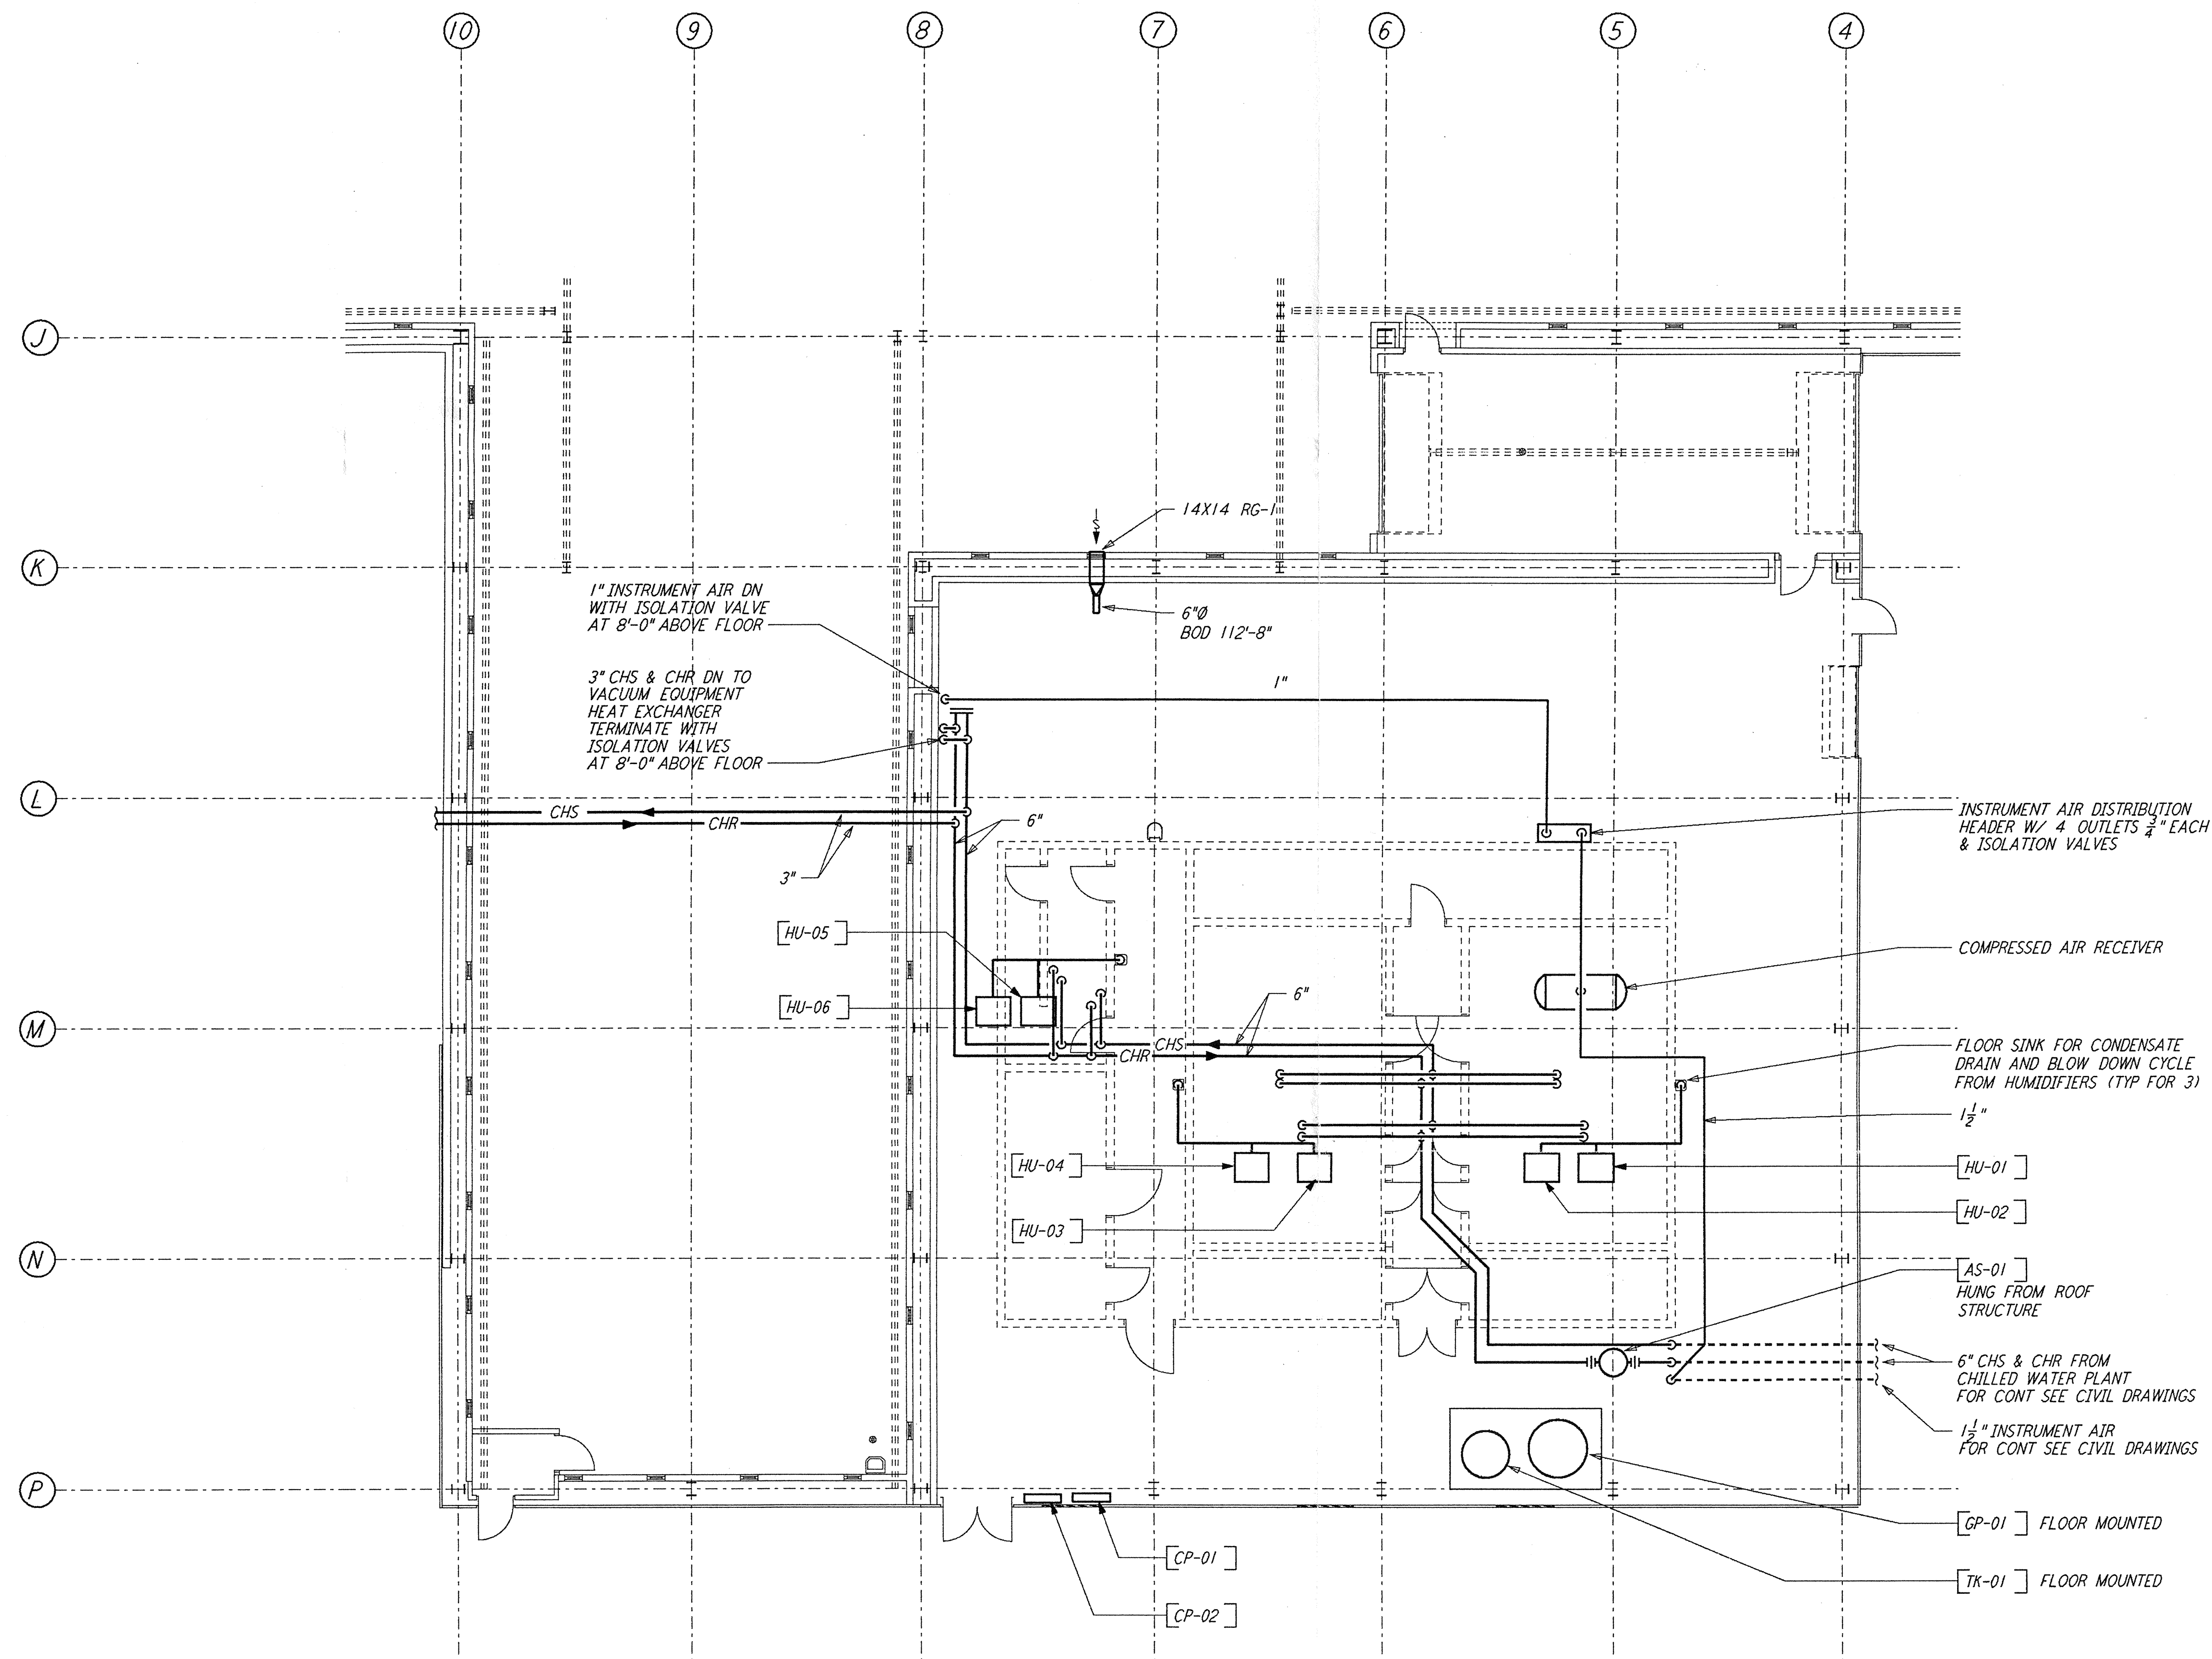


MECHANICAL ROOM PLAN
 3/8" = 1'-0"

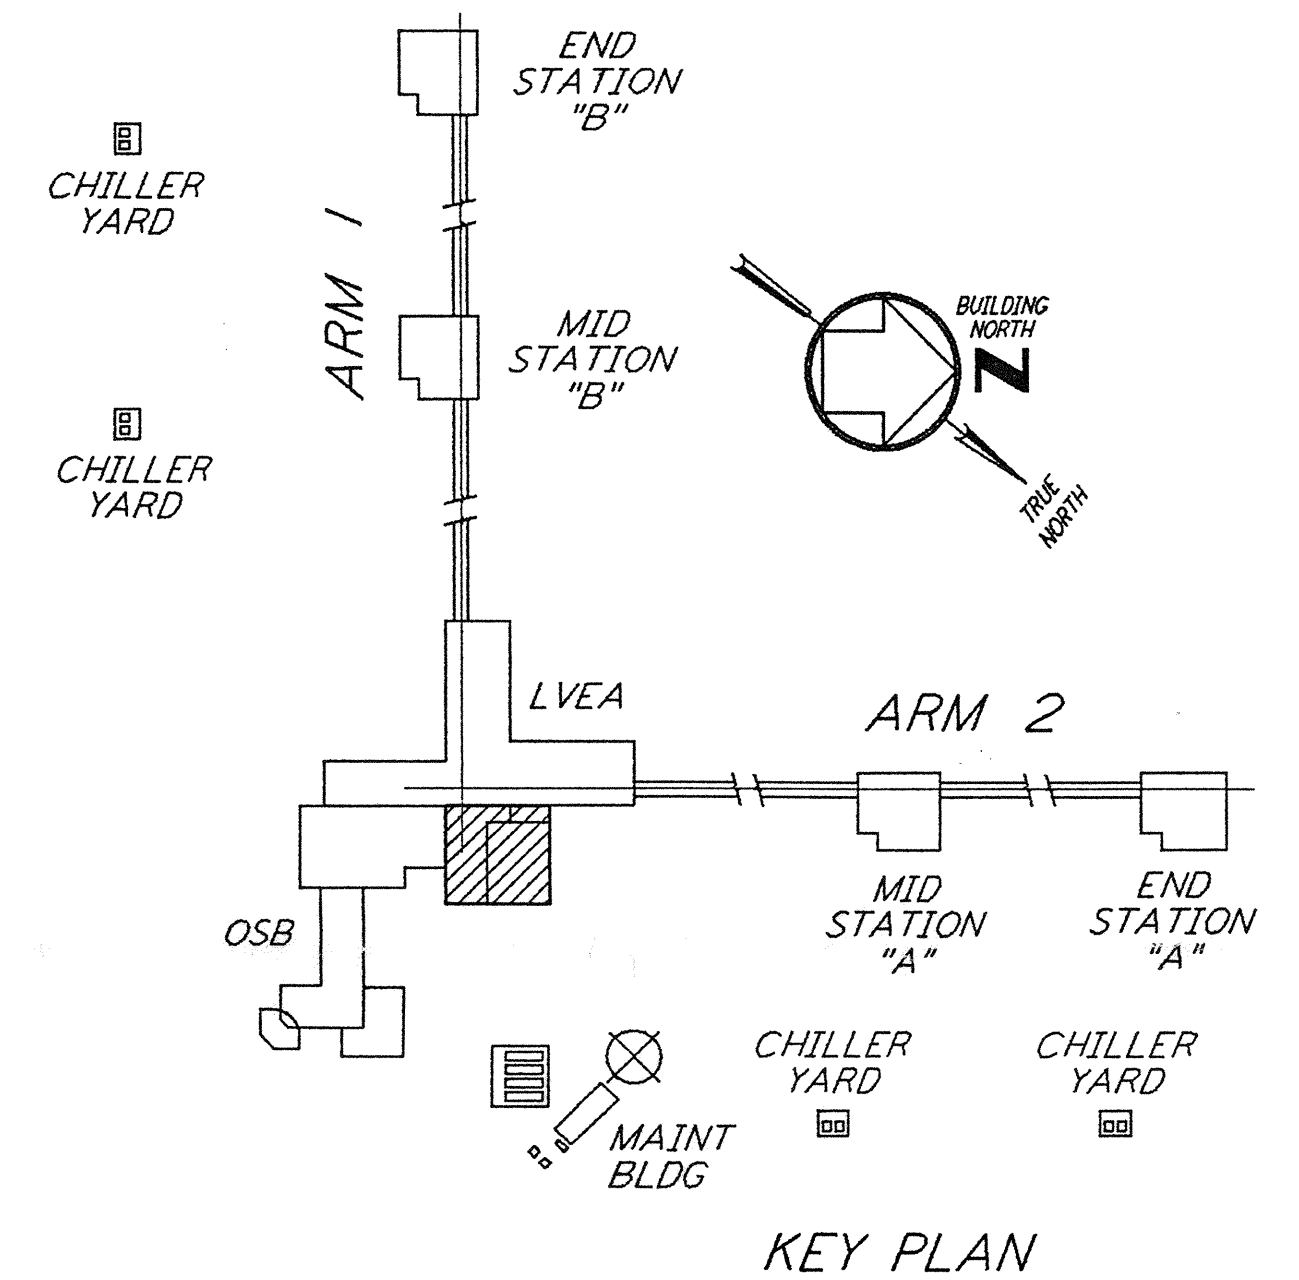

KEY PLAN

Date Received: 4-19-96	LIGO-D 960383-A-D
Collection #: 28	Collection #: WA-H-513 Rev 1
Date: 4/19/96	Approved:
TOM #:	LIGO: C-960857-00-V
Date: / /	Approved:
Client Transmittal:	LIGO:
Date: / /	Approved:

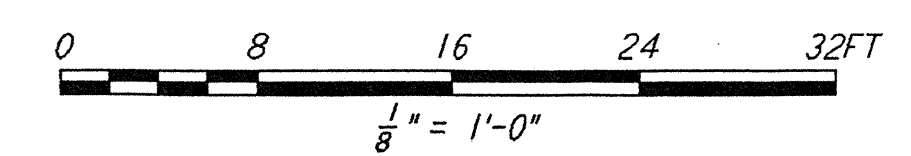

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NO.	DATE	BY	CHKD	ENGR	PRGJ	DESCRIPTION
A	4-19-96	CLP	ME	AA		FINAL DESIGN REVIEW & BID

DRAWN	CLP
CHECKED	
ENGINEER	
PROJ	

100 WEST WALNUT STREET
 PASADENA, CALIFORNIA

CALIFORNIA INSTITUTE OF TECHNOLOGY
 MASSACHUSETTS INSTITUTE OF TECHNOLOGY

LASER INTERFEROMETER
 GRAVITATIONAL-WAVE OBSERVATORY
 SITE NO. 1 - HANFORD, WASHINGTON

TITLE: HVAC CORNER STATION LVEA & OSB MECHANICAL ROOM PIPING PLAN

SCALE: AS NOTED

CONTRACT NUMBER: PPI50969

PROJECT NUMBER: 8094

SHEET NUMBER: WA-H-513

REVISIONS: A