


NOTES:

- 1) FOR INSTRUMENT INSTALLATION DETAILS SEE PSI DVG #V049-3-008.
- 2) ALL INSTRUMENT AIR & PROCESS TUBING SHALL BE 3/8" O.D. X .049 THK SEAMLESS SS316, TYPE 316.
- 3) TUBING ROUTING SHOWN ON PLAN IS DIAGRAMMATICAL AND SHALL BE FIELD VERIFIED SO AS TO OPTIMIZE SUPPORTING MEANS AND TO AVOID INTERFERENCES WITH CONDUIT & PIPING SYSTEMS.

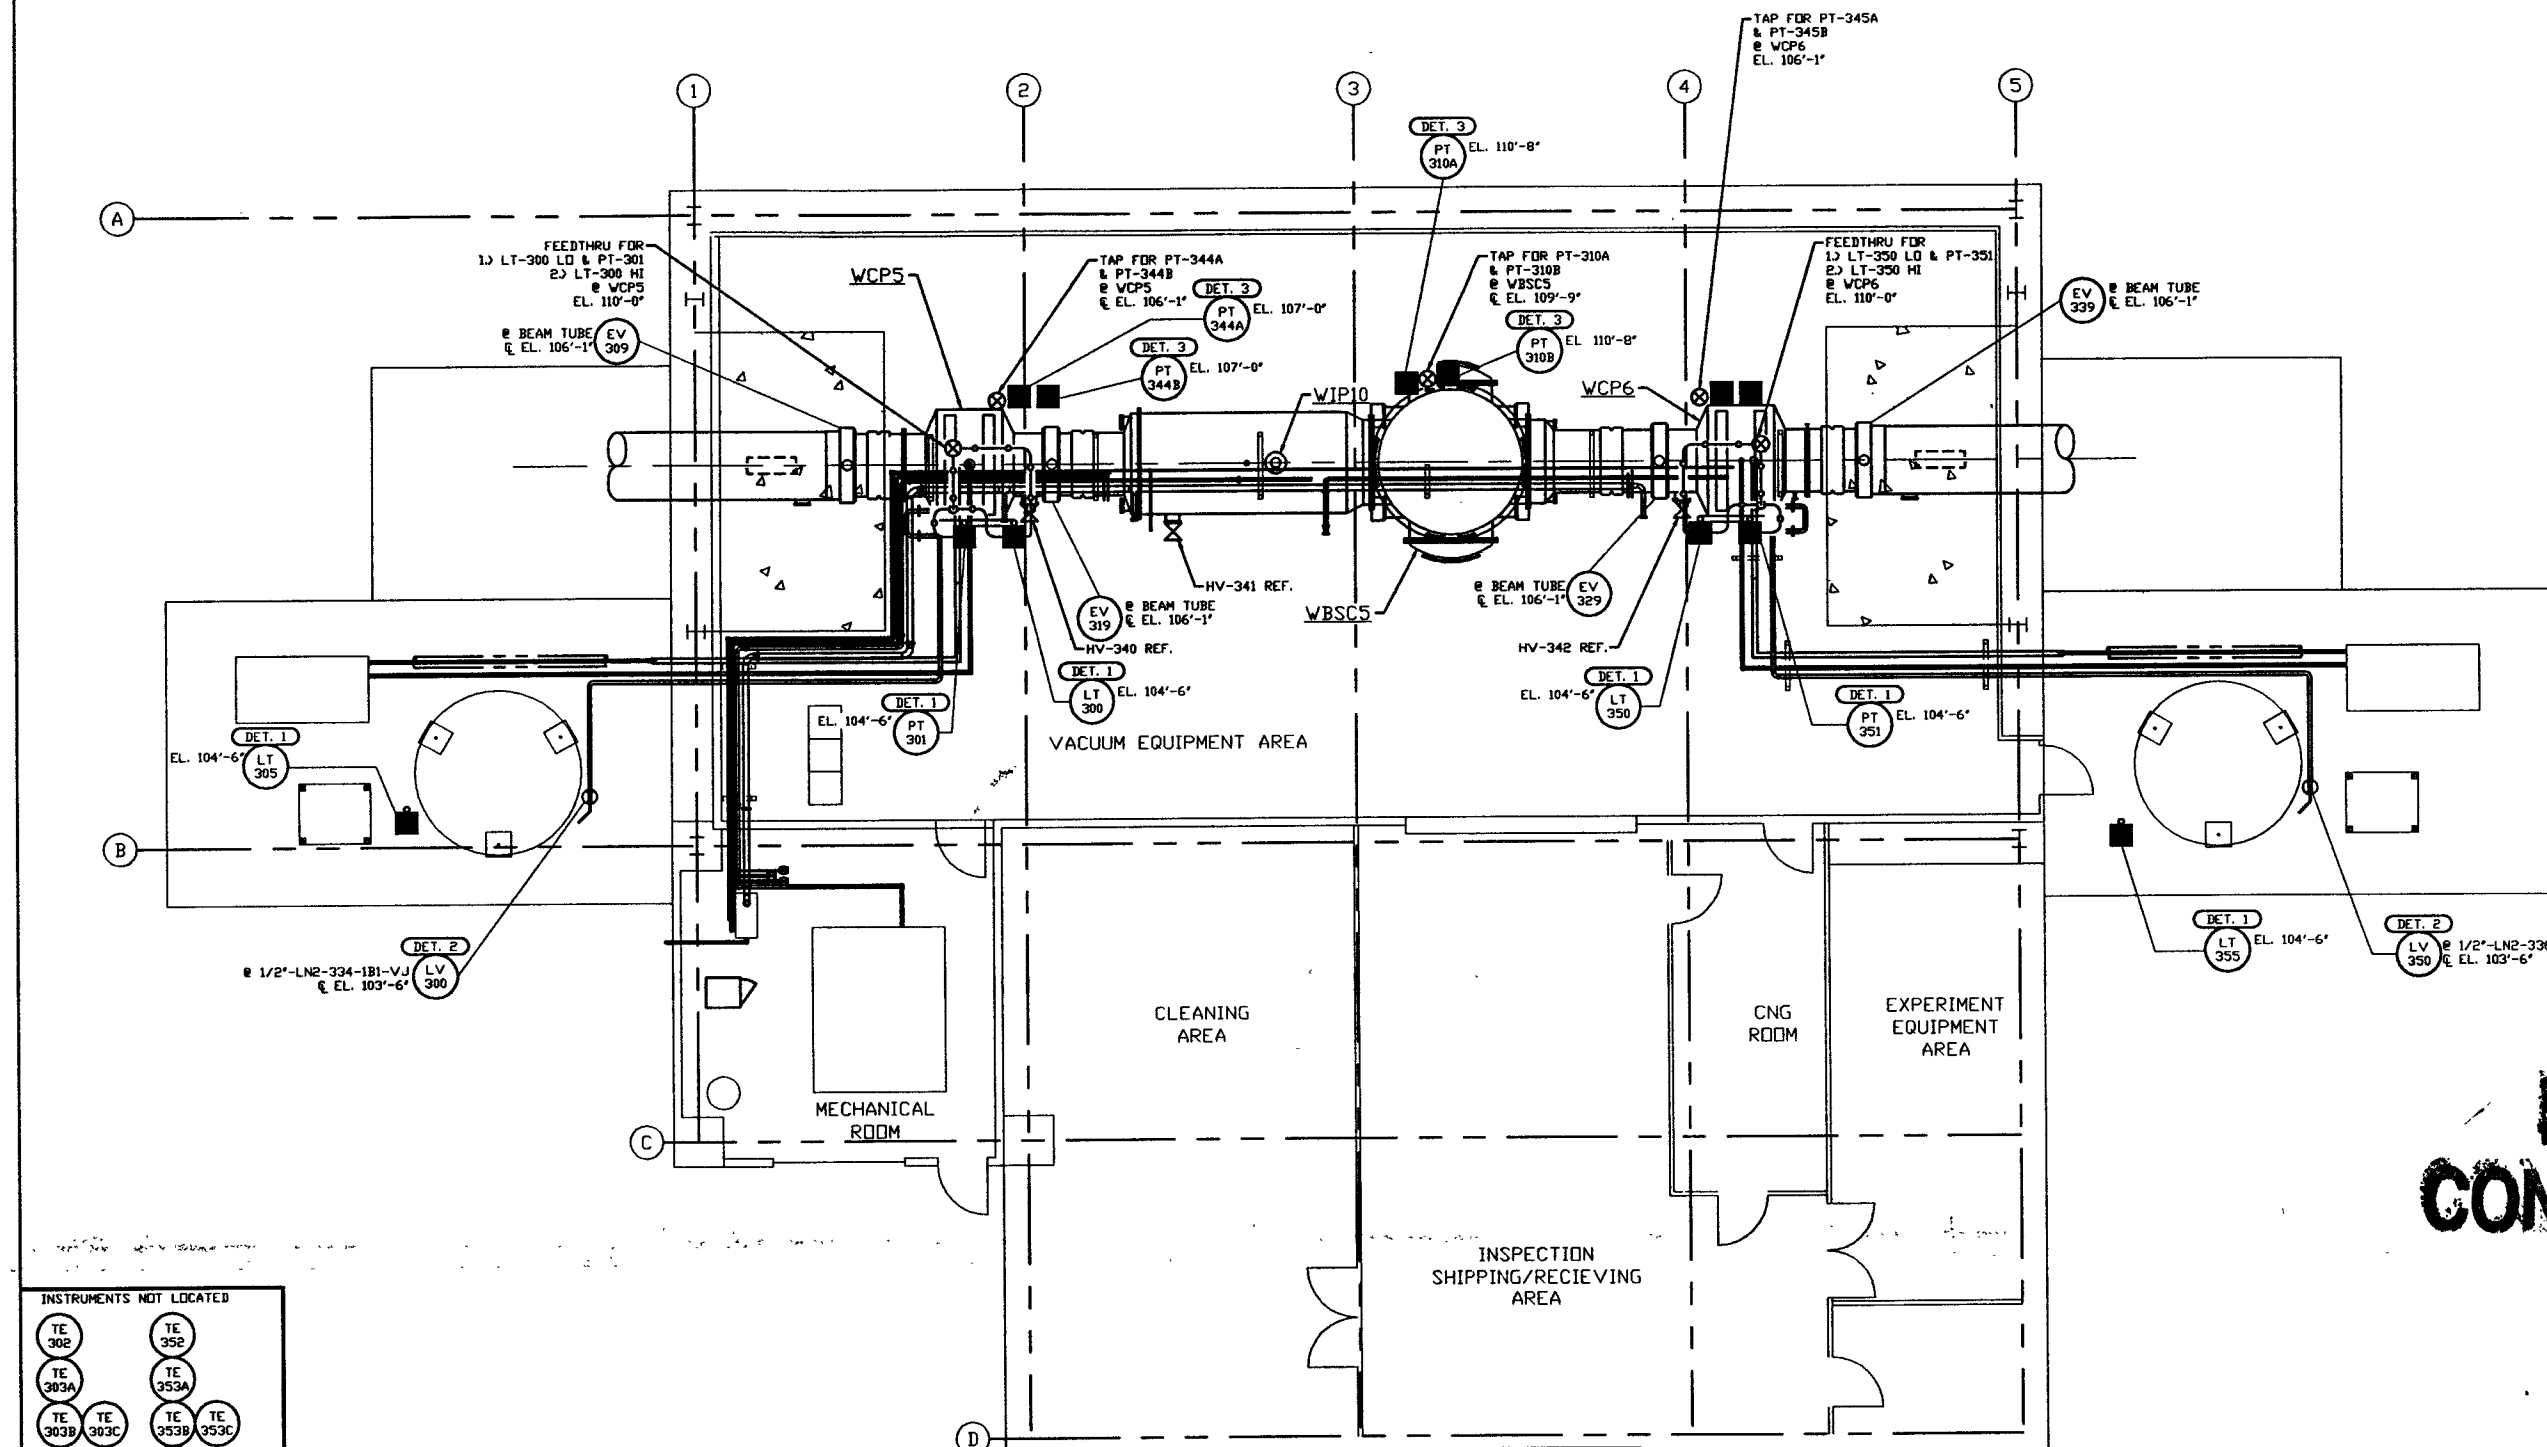

NOT FOR
CONSTRUCTION

INSTRUMENTS NOT LOCATED

TE 302	TE 352
TE 303A	TE 353A
TE 303B	TE 353B
TE 303C	TE 353C
TY 303	TY 353
FE 304	FE 354
FI 304	FI 354
PCV 310	

- LEGEND**
- INSTRUMENT LOCATION
 - XX --- INSTRUMENT IDENTIFICATION
 - DET. X INSTALLATION DETAIL (SEE NOTE 1)
 - ⊗ PROCESS TAP
 - PROCESS TUBING (SEE NOTE 2)

LIGO-D960583-00-V

<p>PROPRIETARY AND CONFIDENTIAL</p> <p>THIS DOCUMENT CONTAINS PROPRIETARY INFORMATION BELONGING TO PROCESS SYSTEMS INTERNATIONAL, INC. OR ITS AFFILIATED COMPANIES AND SHALL BE USED ONLY FOR THE PURPOSE FOR WHICH IT WAS SUPPLIED. IT SHALL NOT BE COPIED, REPRODUCED OR OTHERWISE USED FOR ANY OTHER PURPOSE WITHOUT THE WRITTEN CONSENT OF PROCESS SYSTEMS INTERNATIONAL, INC. AND SHALL BE RETURNED UPON REQUEST.</p>		<p>V049-5-004 EQUIP. ARRANGEMENT WASHINGTON RIGHT MID STATION</p> <p>V049-3-008 INSTRUMENT INSTALLATION DETAILS</p> <p>V049-3-002 WASHINGTON OVERALL SITE PLAN</p> <p>V049-3-001 GENERAL NOTES & LEGEND</p> <p>V049-0-016 P & I D WASHINGTON RIGHT MID STATION</p>		<p>UNLESS OTHERWISE SPECIFIED DIMENSIONS ARE IN INCHES</p> <p>TOLERANCES:</p> <p>FRACTIONAL & ANGULAR DIMS: 1/16" & 30°-30' 30" 30"</p> <p>THREE PLACE DECIMAL & 90° FINISHED SURFACE DIMS: REMOVE ALL BURRS</p>		<p>DO NOT SCALE THIS DRAWING</p> <p>ISSUE FOR FDR</p> <p>USED ON: _____</p> <p>REV: _____</p> <p>DESCRIPTION: _____</p> <p>ISSUE DESCRIPTION: _____</p>		<p>DATE: 04.26.96</p> <p>DESN: _____</p> <p>CHKD: _____</p> <p>DRWN: _____</p>		<p>SCALE: 3/16" = 1' - 0"</p> <p>SHEET: 1 OF 1</p>	
<p>PROCESS SYSTEMS INTERNATIONAL, INC.</p> <p>30 WALLOP DR. WESTBOROUGH, MASSACHUSETTS 01581 USA</p>		<p>INSTRUMENT PLAN</p> <p>LIGO VACUUM EQUIPMENT</p> <p>WASHINGTON SITE</p> <p>RIGHT MID STATION</p>		<p>CAD FILE: V0493301</p> <p>SIZE: D</p> <p>DWG. NO.: V049-3-301</p> <p>REV: 0</p>		<p>DATE: 04.26.96</p> <p>DESN: _____</p> <p>CHKD: _____</p> <p>DRWN: _____</p>		<p>SCALE: 3/16" = 1' - 0"</p> <p>SHEET: 1 OF 1</p>			