





- NOTES:**
1. SEE SHEET LA-C-002 FOR GENERAL NOTES, LEGEND AND ABBREVIATIONS.
  2. SEE SHEET LA-C-004 FOR TYPICAL SECTIONS AND DETAILS.

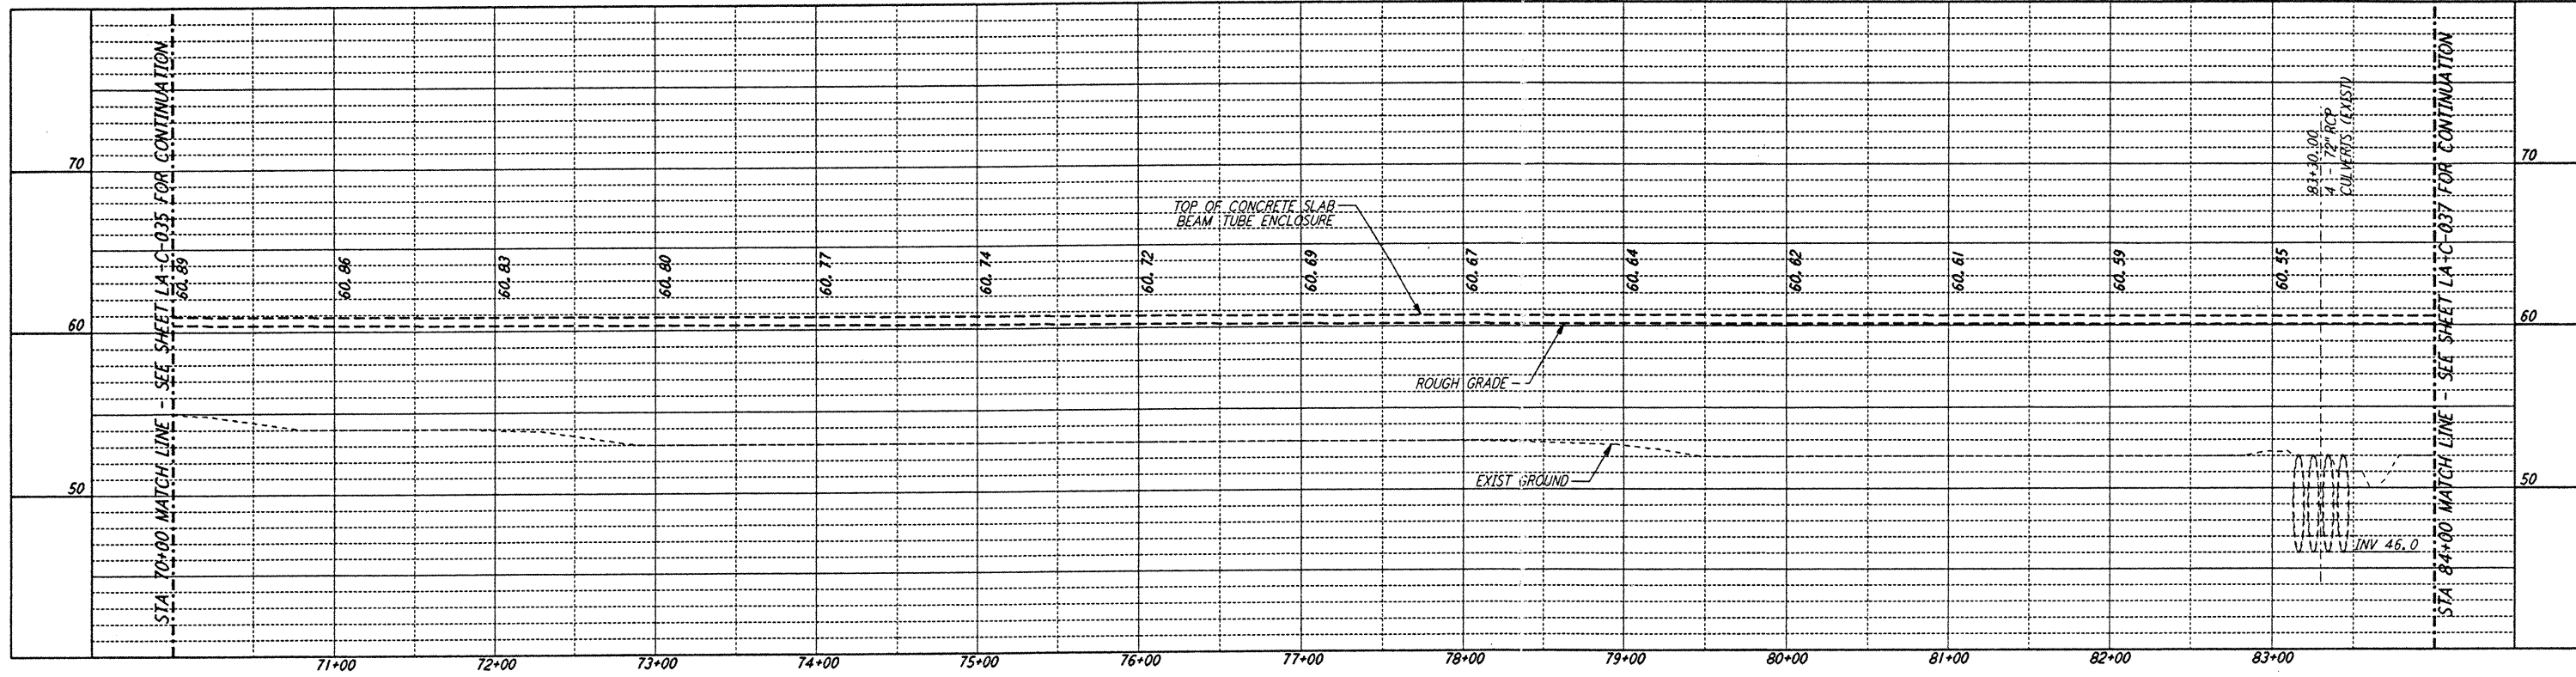

**PROFILE**  
 SCALES: HORIZ: 1" = 50'  
 VERT: 1" = 5'

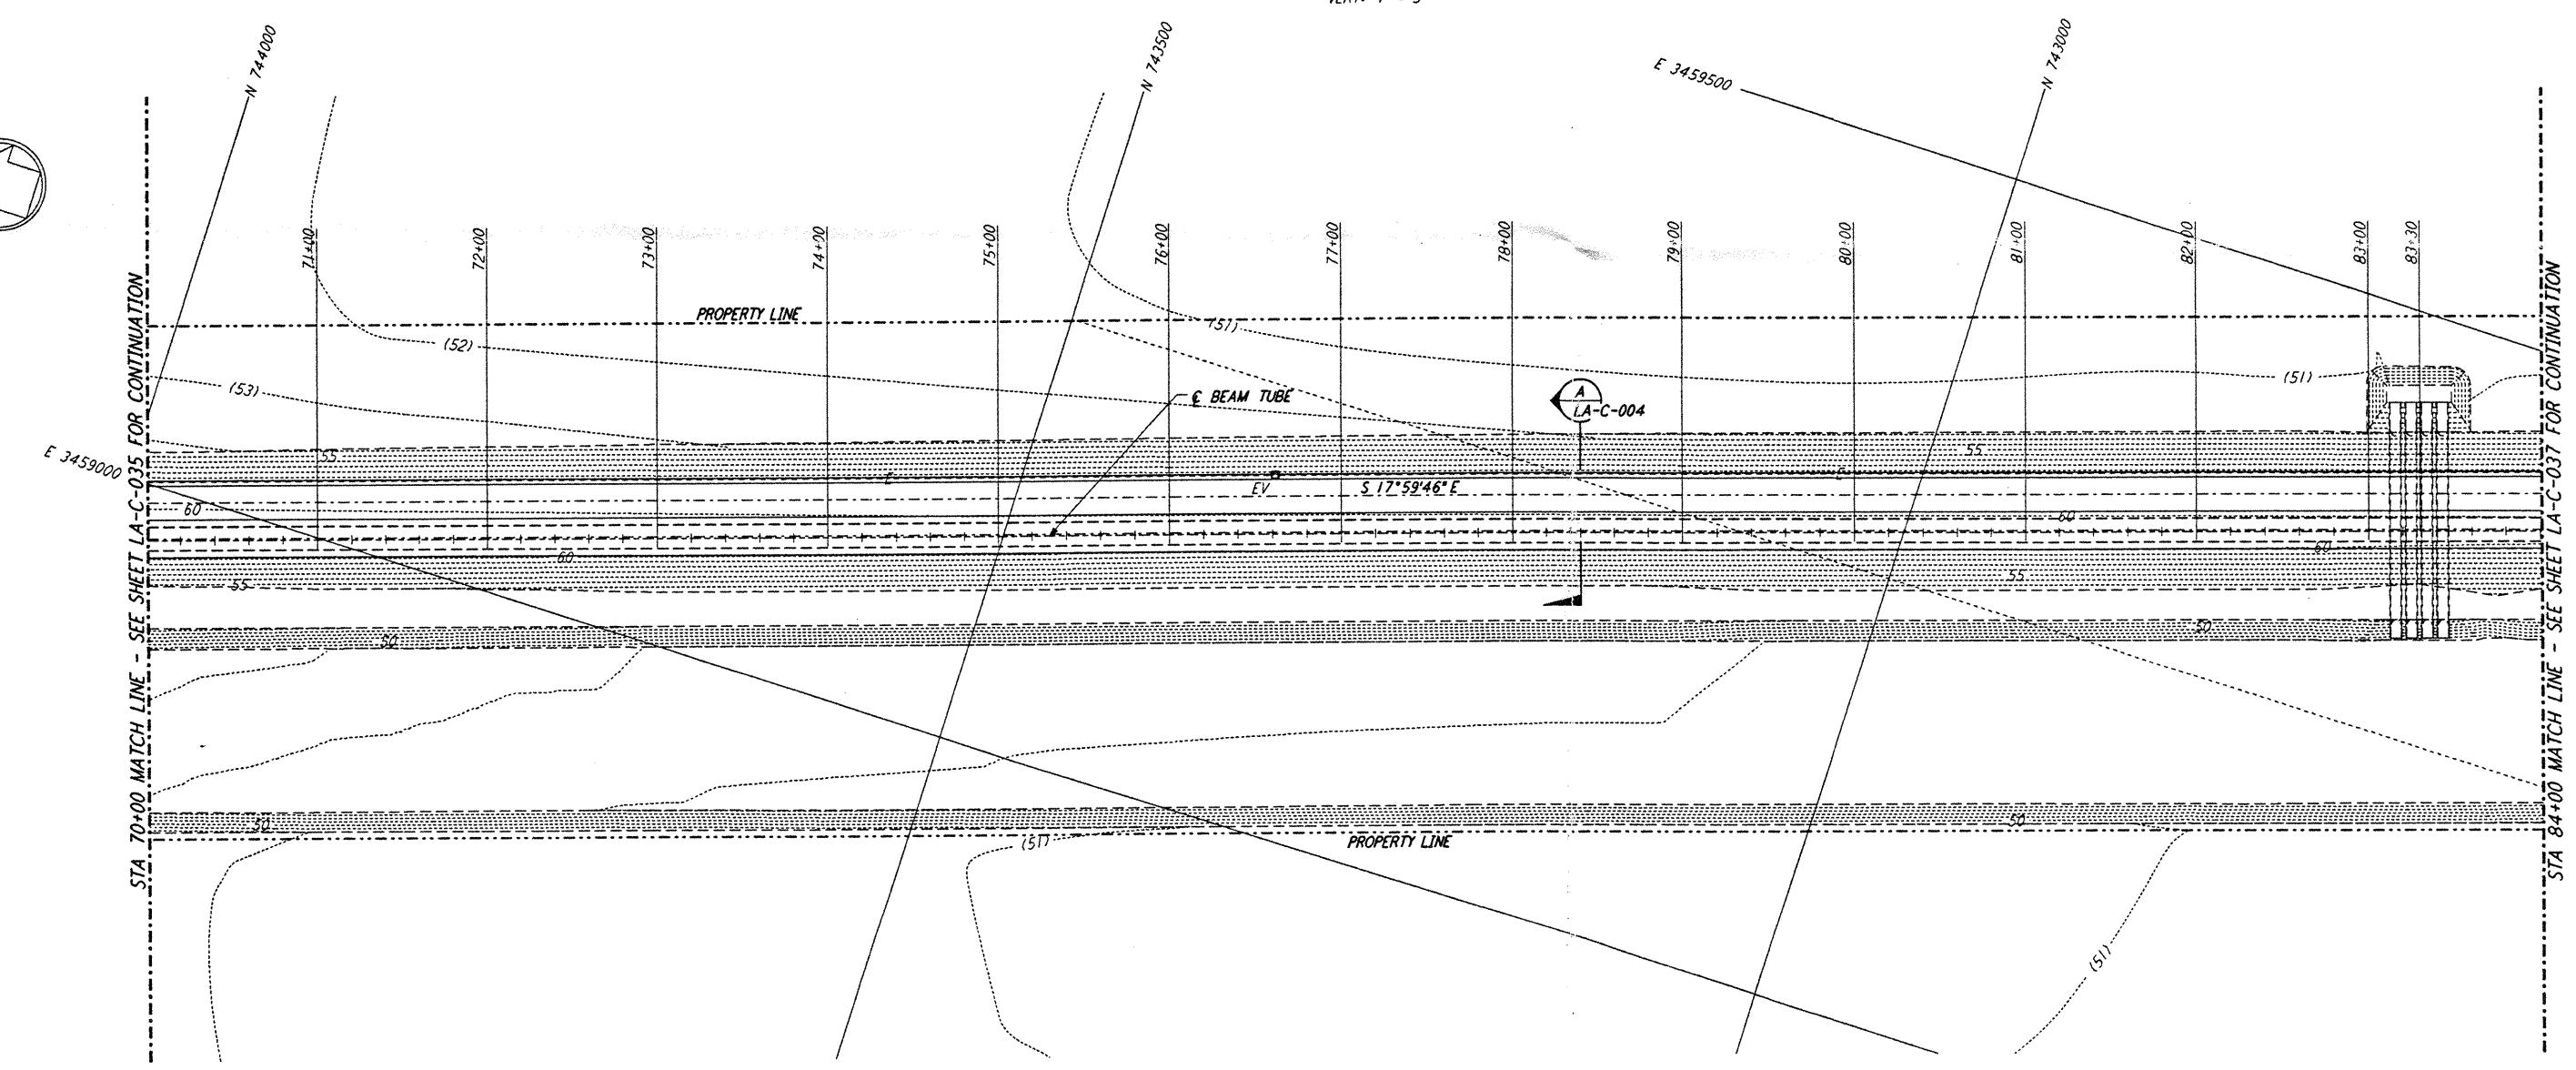

**PLAN**  
 SCALE: 1" = 50'

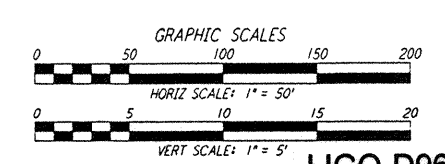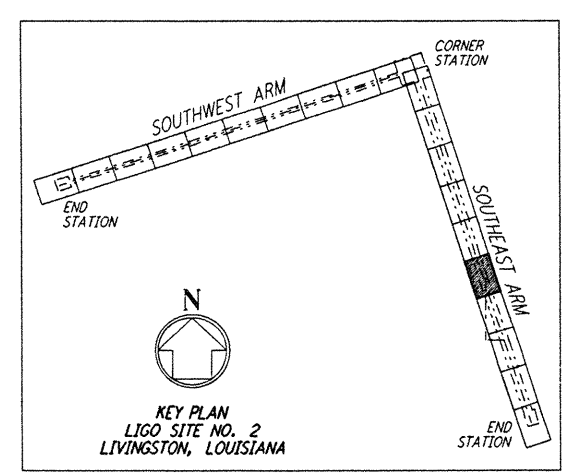

LIGO-D960850-A-O

**LASER INTERFEROMETER GRAVITATIONAL-WAVE OBSERVATORY SITE NO. 2 - LIVINGSTON, LOUISIANA**

CIVIL SOUTHWEST ARM PLAN AND PROFILE STA 70+00 TO STA 84+00

SCALE AS NOTED CONTRACT NUMBER PPI 50969 PROJECT NUMBER 8094 SHEET NUMBER **LA-C-036**

**PARSONS**

100 WEST WALNUT STREET PASADENA, CALIFORNIA

**LIGO**

CALIFORNIA INSTITUTE OF TECHNOLOGY MASSACHUSETTS INSTITUTE OF TECHNOLOGY

REFERENCES									
DRAWING NO.	DESCRIPTION	NO.	DATE	BY	CHKD	ENGR	PROJ	DESCRIPTION	
		A	6/14/96	WRB				FINAL DESIGN REVIEW	

This document and the design it covers are the property of PARSONS. They are loaned only with the borrower's expressed written agreement that they will not be reproduced, copied, loaned, exhibited, or used in any other way, except by written consent from PARSONS to the borrower.

M80 JUN 17 08:51:17 PM S:\Y\BOL...JANLUIS\SUBDIRS\2\Y\BOL\VEDRSHUPIT

M80 JUN 14 20:52:47 PM S:\Y\BOL...JANLUIS\SUBDIRS\2\Y\BOL\VEDRSHUPIT