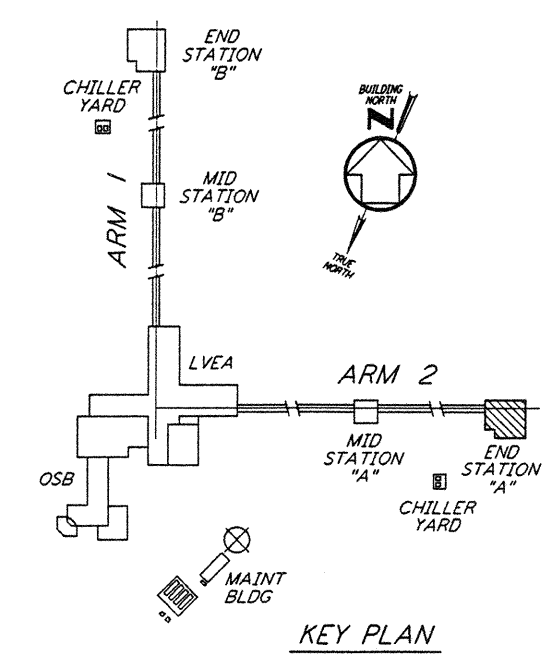
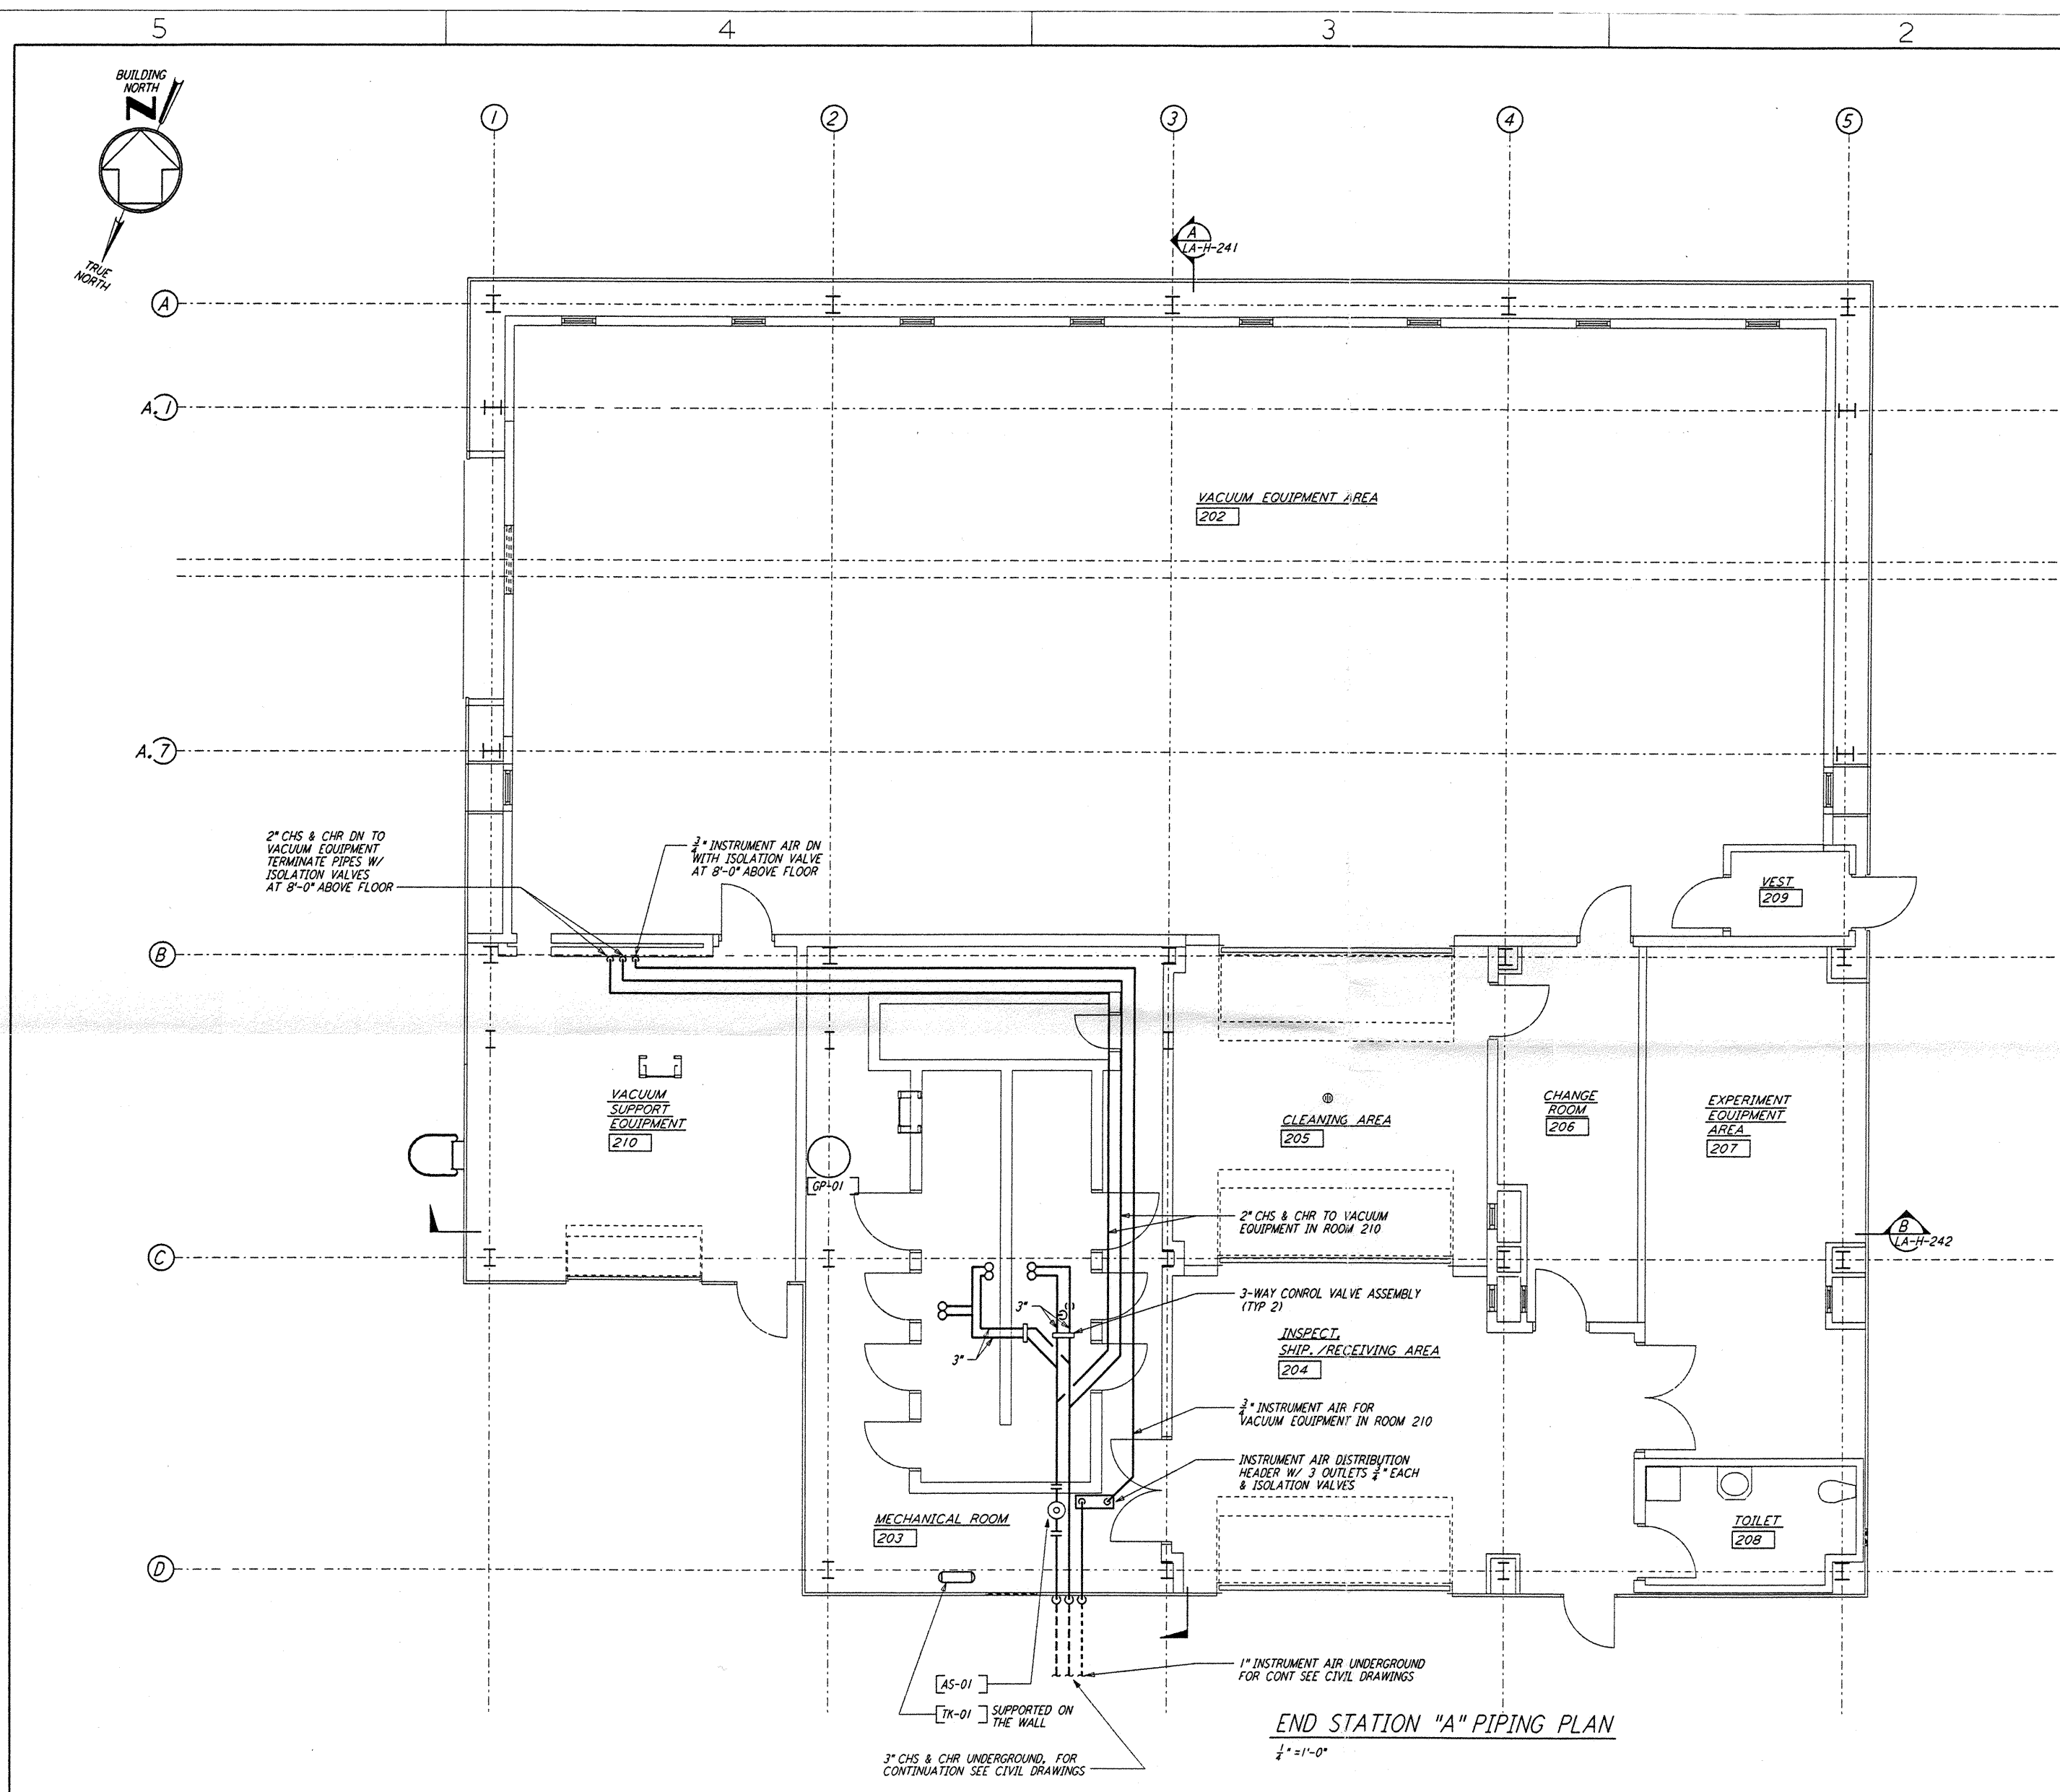


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0 4 8 12 16 FT  
 1/4" = 1'-0"

LIGO-D960986-A-O

NO.	DATE	BY	CHKD	ENGR	PROJ	DESCRIPTION
A	6-14-96	CLP	TKS	AR	ADJ	FINAL DESIGN REVIEW

DRAWN	CLP
CHECKED	
ENGINEER	
PROJ	

**PARSONS**  
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 PASADENA, CALIFORNIA

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LASER INTERFEROMETER GRAVITATIONAL-WAVE OBSERVATORY SITE NO. 2 - LIVINGSTON, LOUISIANA			
TITLE	SCALE	CONTRACT NUMBER	PROJECT NUMBER
HVAC END STATION "A" PIPING PLAN	AS NOTED	PP150969	8094
SHEET NUMBER		REVISION	
LA-H-215			