
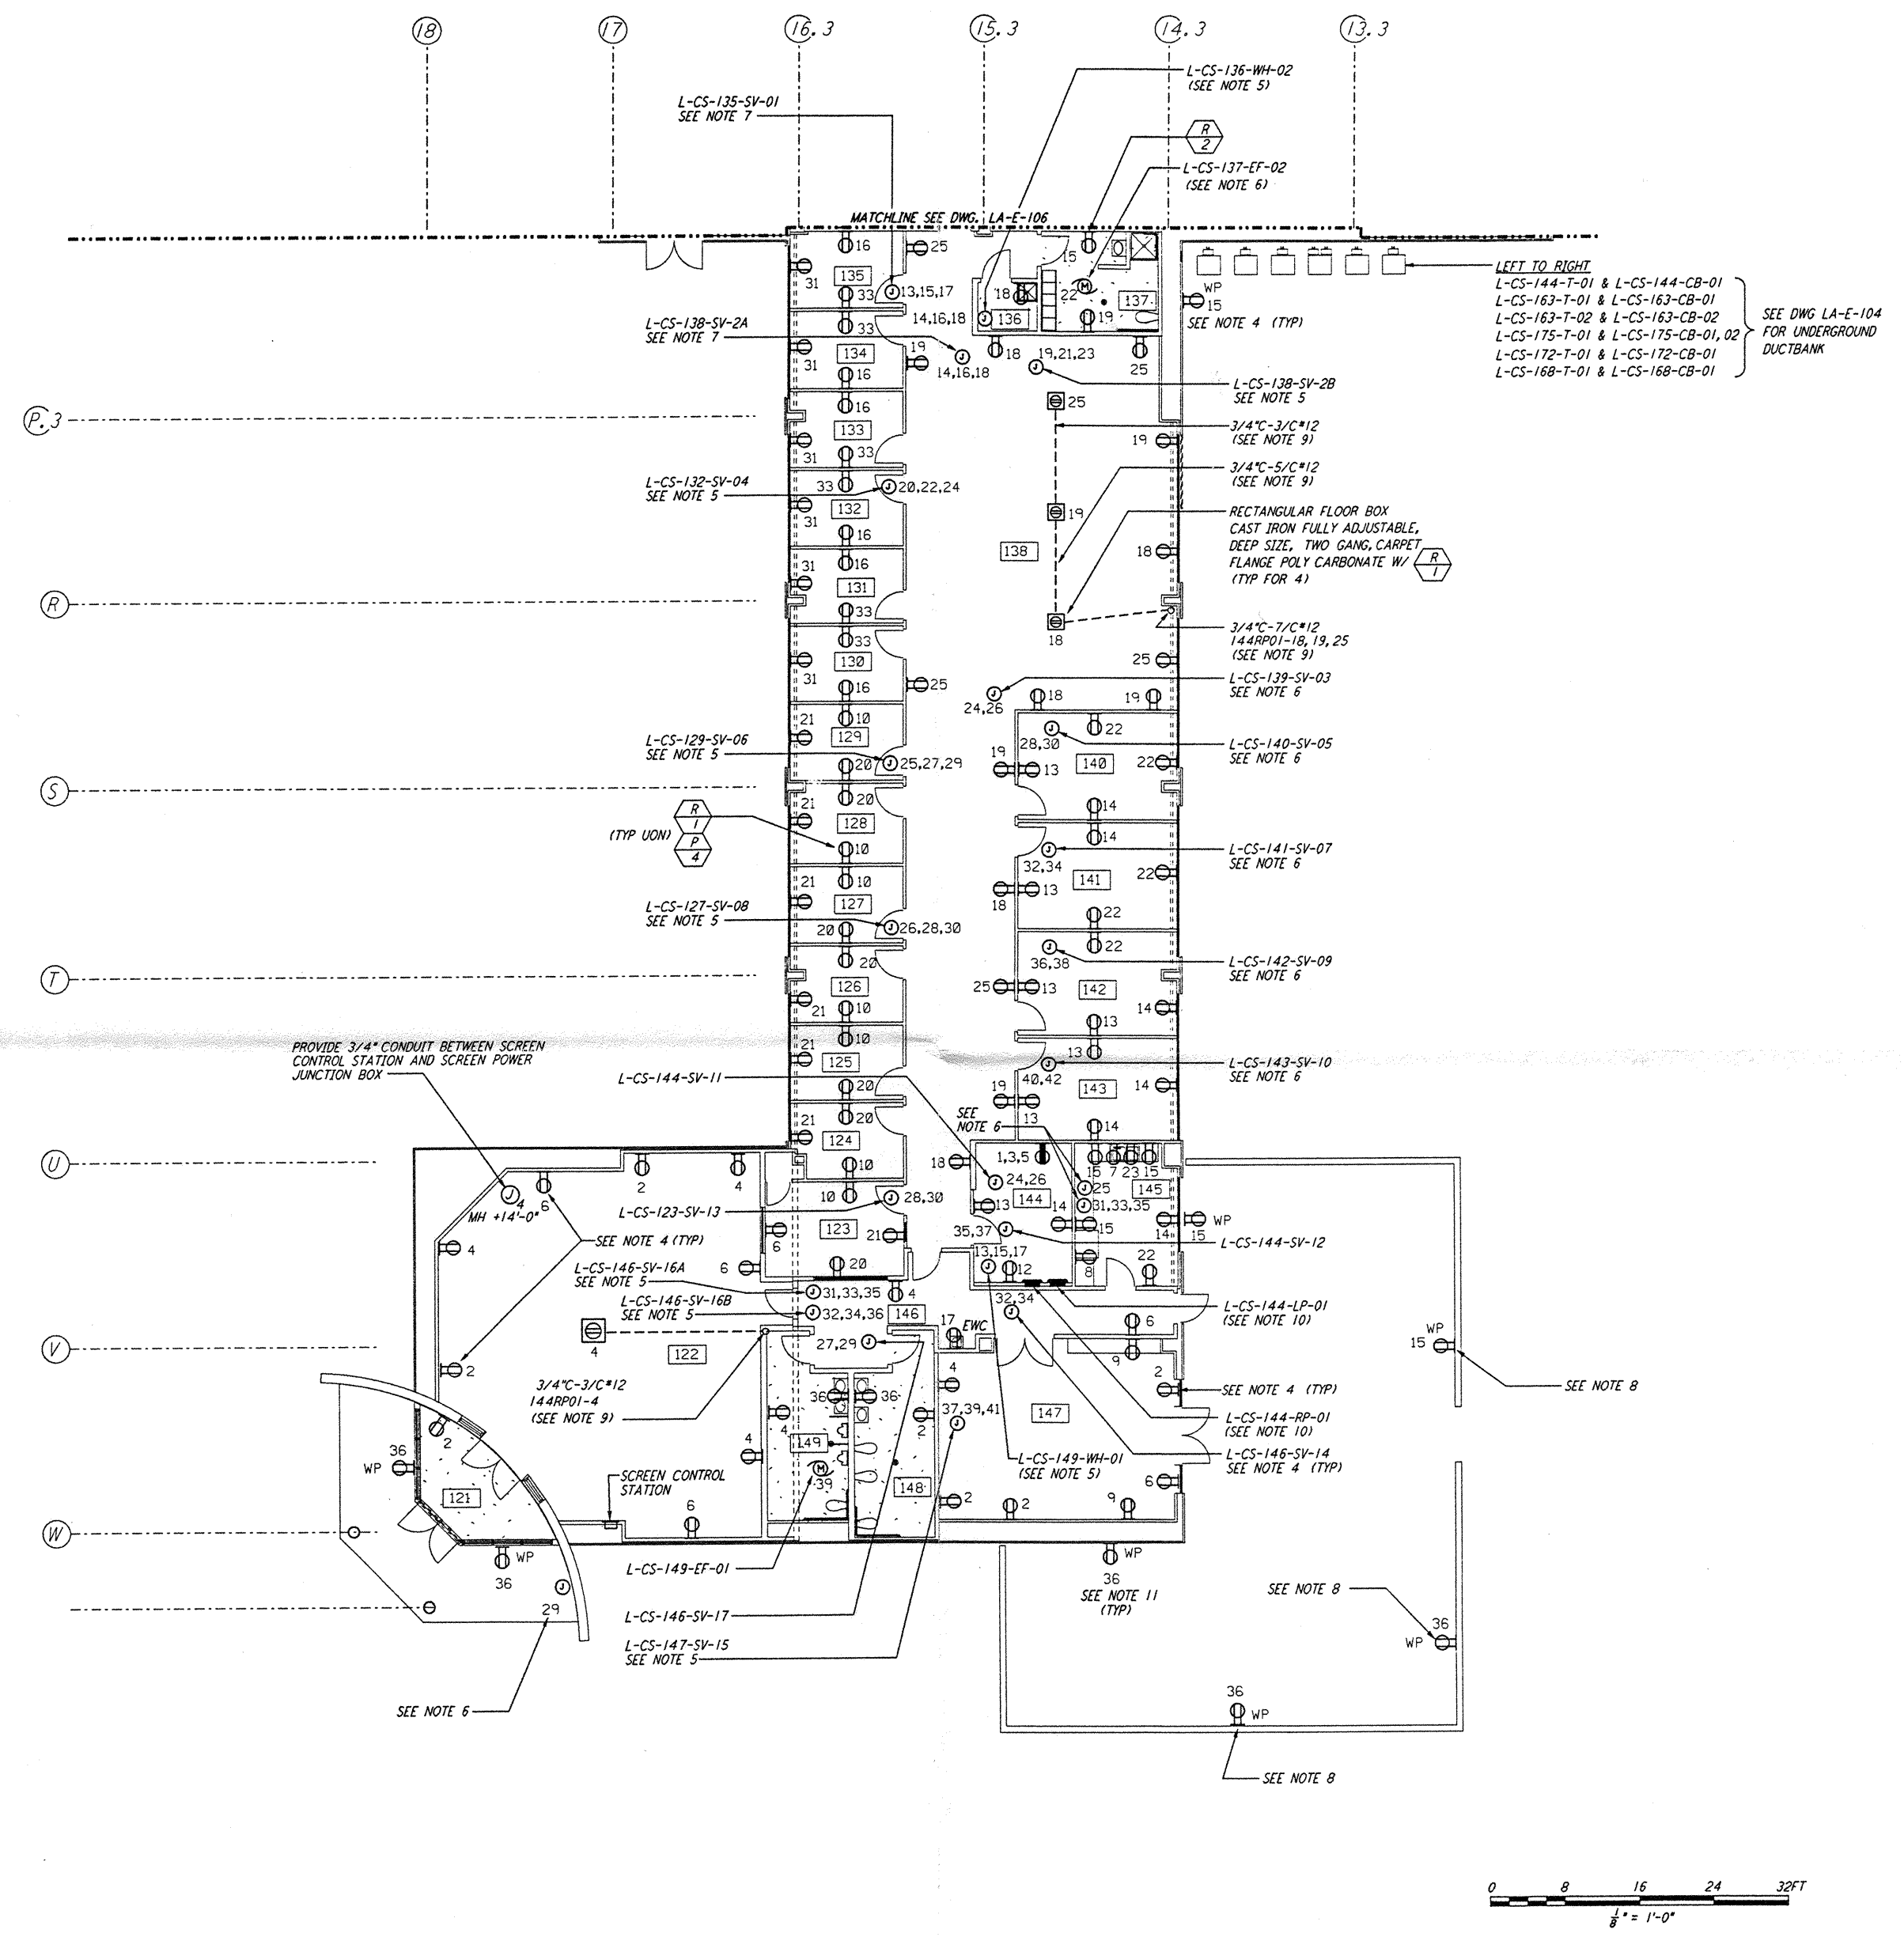


5

4

3

2

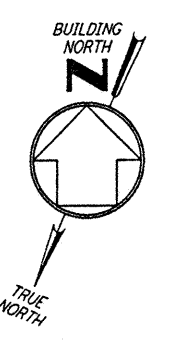

NOTES:



1. FOR ABBREVIATIONS AND ACRONYMS SEE DWG LA-E-001.
2. FOR SYMBOLS SEE DWG LA-E-002.
3. FOR GENERAL NOTES, SEE DWG LA-E-101.
4. ALL CIRCUITS SHOWN ON THIS DRAWING ARE FROM PANEL L-CS-144-RP-01 UNLESS OTHERWISE NOTED.
5. CIRCUITS SHOWN FEEDING THESE ITEMS ARE FROM PANEL L-CS-144-LP-01.
6. CIRCUITS SHOWN FEEDING THIS ITEM IS FROM PANEL L-CS-163-RP-01.
7. CIRCUITS SHOWN FEEDING THESE ITEMS ARE FROM PANEL L-CS-163-LP-01.
8. CONDUIT AND WIRE FEEDING RECEPTACLES LOCATED ON PATIO WALLS SHALL ROUTE WITHIN PATIO BLOCK WALLS TO EXTERIOR WALLS OF THE OSB AS REQUIRED.
9. CONDUIT AND WIRE SHALL ROUTE WITHIN FLOOR SLAB TO WALL AS INDICATED.
10. FOR ALL PANEL FEEDER CONDUIT AND CABLE SIZES SEE SINGLE LINE DIAGRAM DWG LA-E-006. ROUTE CABLES IN CONCEALED CONDUIT TO L-CS-107-SB-01. FOR LOCATION SEE DWG LA-E-100.
11. SEE PANEL SCHEDULES ON DWG LA-E-115 & LA-E-116 FOR GFCI CIRCUITS.

REFERENCE DRAWINGS:

- LA-E-115 LIGHTING AND POWER PANEL SCHEDULES
- LA-E-116 LIGHTING AND POWER PANEL SCHEDULES


not be reproduced, copied, loaned, exhibited, or used in any other way, except by written consent from PARSONS to the borrower.

This document and the design it covers are the property of PARSONS. They are loaned only with the borrower's expressed written agreement that they will

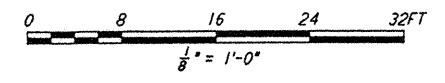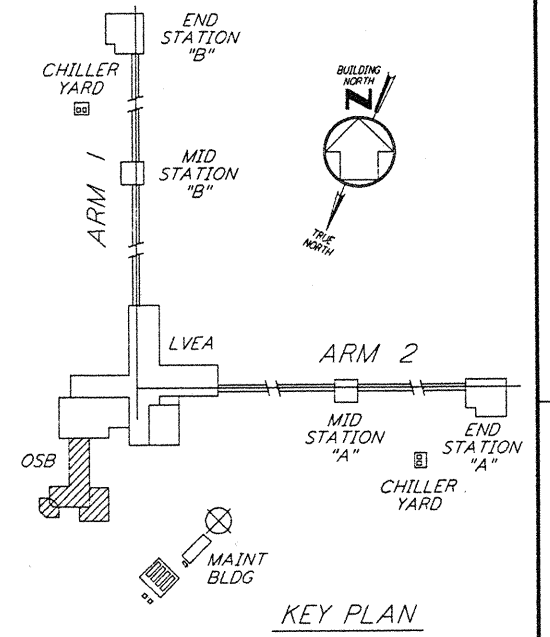

NO.	DATE	BY	CHKD	ENGR	PROJ	DESCRIPTION

ISSUED FOR CONSTRUCTION	M.M.	11-15-96
DRAWN	LJL	7-24-96
CHECKED	LJL	10-25-96
ENGINEER	LJL	11/15/96
PROJ		

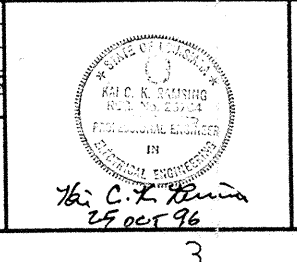

PARSONS
 100 WEST WALNUT STREET
 PASADENA, CALIFORNIA

LIGO
 CALIFORNIA INSTITUTE OF TECHNOLOGY
 MASSACHUSETTS INSTITUTE OF TECHNOLOGY

LASER INTERFEROMETER
 GRAVITATIONAL-WAVE OBSERVATORY
 SITE NO. 2 - LIVINGSTON, LOUISIANA

TITLE: ELECTRICAL CORNER STATION OSB OFFICE AREA RECEPTACLE & POWER PLAN

SCALE: AS NOTED

CONTRACT NUMBER: PPI50969

PROJECT NUMBER: 8094

SHEET NUMBER: **LA-E-105**

REVISIONS:

5

4

3

2

Ligo-0961007-00-0

LIGOLAF3.BDR

100 LIGOLAF3.BDR 10/22/96 5:57:26Z J:\VL015\WDL015\3\06\KLE\BDR\LA-E-105.DWG

100 LIGOLAF3.BDR 10/22/96 5:57:26Z J:\VL015\WDL015\3\06\KLE\BDR\LA-E-105.DWG