

LEGEND:

- WP RECEPTACLE, 208V, 3Ø, 5W, 4 POLE GROUNDING
NEMA L21-3ØR HUBBELL #2810 WITH WEATHERPROOF BOX AND COVER
- RECEPTACLE, 208V, 3Ø, 5W, 4 POLE GROUNDING
NEMA L21-3ØR HUBBELL #2810 WITH BOX AND COVER

NOTES:

- FOR ABBREVIATIONS AND ACRONYMS SEE DWG. LA-E-001.
- FOR SYMBOLS SEE DWG. LA-E-002.
- FOR GENERAL NOTES SEE DWG. LA-E-100.
- PANELS L-CS-175-RP-01 AND L-CS-175-RP-02 ARE RESERVED FOR CUSTOMER USE.
- CIRCUIT SHOWN FEEDING THIS ITEM IS FROM PANEL W-CS-107-IP-02. FOR LOCATION SEE DWG LA-E-100.
- FOR ALL PANEL FEEDER CONDUIT AND CABLE SIZES SEE SINGLE LINE DIAGRAM DWG LA-E-006. ROUTE CABLES IN CONCEALED CONDUIT TO L-CS-107-SB-01. FOR LOCATION SEE DWG LA-E-100.
- SEE PANEL SCHEDULES ON DWG LA-E-115 & LA-E-116 FOR GFCI CIRCUITS.



REFERENCE DRAWINGS:

- LA-E-109 COMMUNICATION RISER DIAGRAM
- LA-E-115 LIGHTING AND POWER PANEL SCHEDULES
- LA-E-116 LIGHTING AND POWER PANEL SCHEDULES



This document and the design it covers are the property of PARSONS. They are loaned only with the borrower's expressed written agreement that they will not be reproduced, copied, loaned, exhibited, or used in any other way, except by written consent from PARSONS to the borrower.

This document and the design it covers are the property of PARSONS. They are loaned only with the borrower's expressed written agreement that they will not be reproduced, copied, loaned, exhibited, or used in any other way, except by written consent from PARSONS to the borrower.

10/22/96 11:50:11 537496Z JAVLUJUN05EY00ZVLE1060101

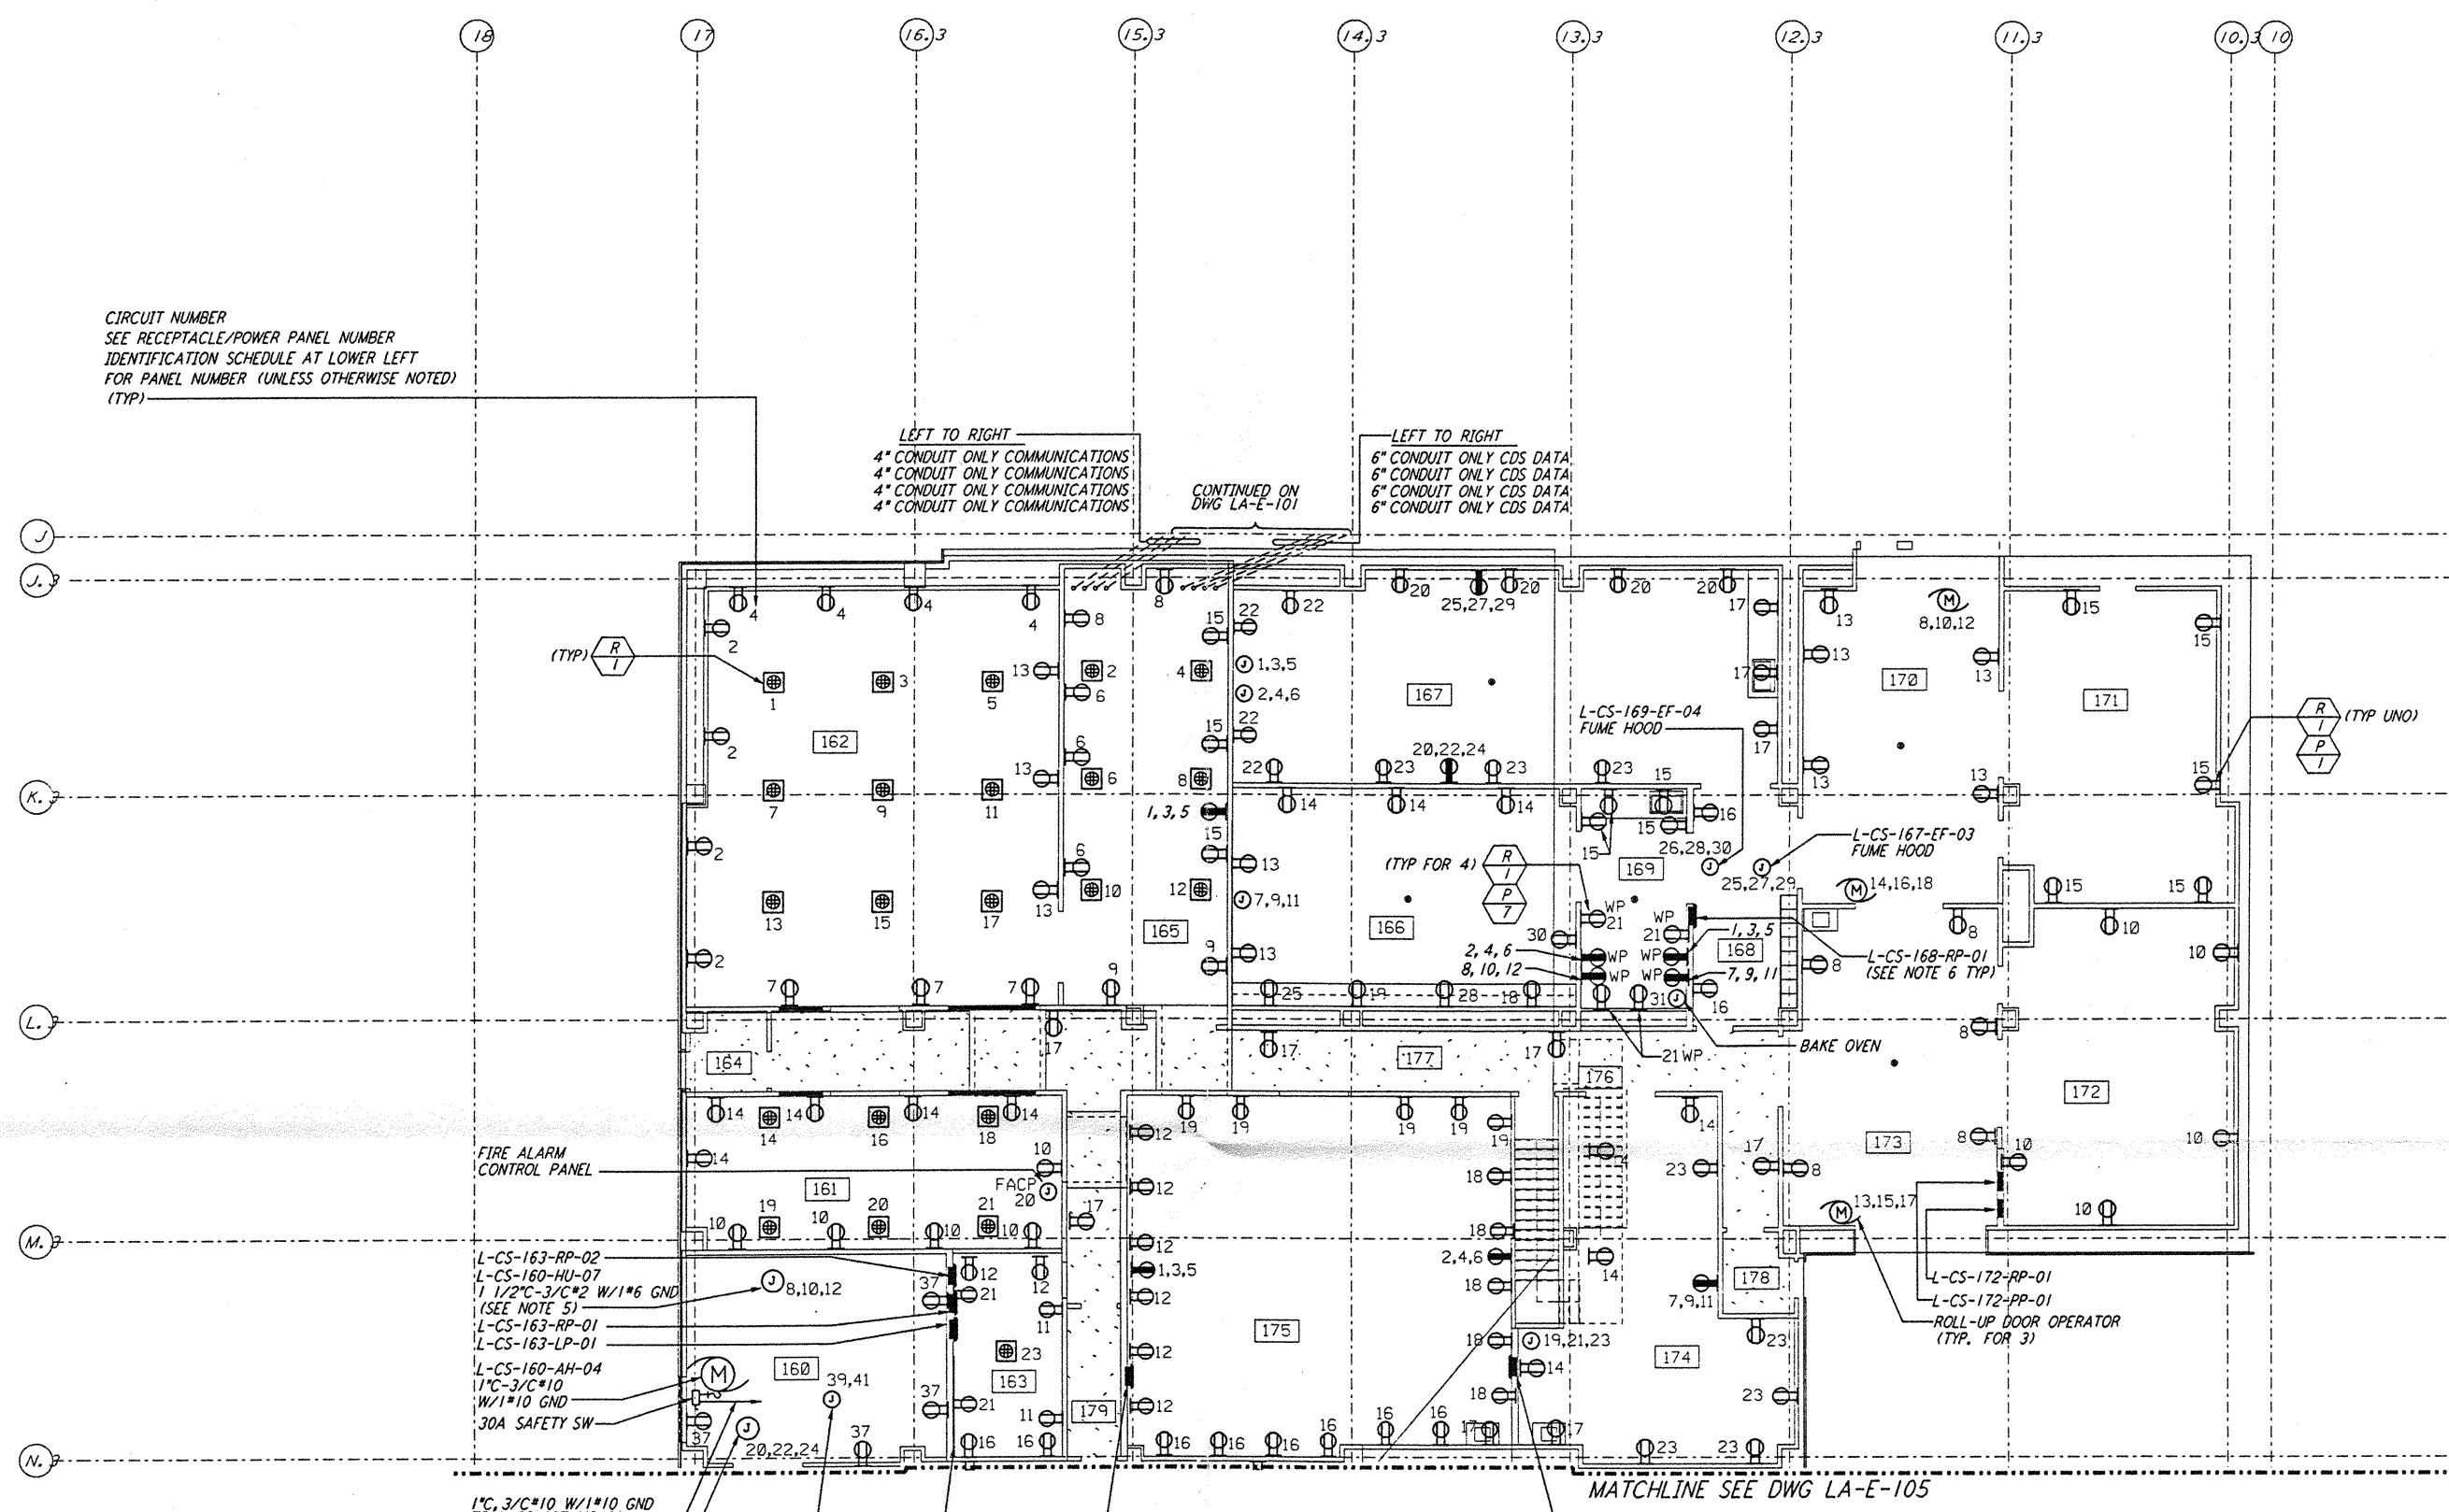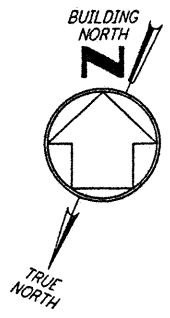


ROOM NUMBER	PANEL NUMBER FOR DUPLEX RECEPTACLE	PANEL NUMBER FOR DUAL-DUPLEX RECEPTACLE	PANEL NUMBER FOR 3Ø, 5-POLE RECEPTACLE	PANEL NUMBER FOR JUNCTION BOX FOR ROLL-UP DOOR OPERATOR	PANEL NUMBER FOR ROLL-UP DOOR OPERATOR
160	L-CS-163-RP-01	---	---	L-CS-163-RP-01	---
161	L-CS-163-RP-01	L-CS-163-RP-02	---	L-CS-163-RP-01	---
162	L-CS-163-RP-01	L-CS-163-RP-02	---	---	---
163	L-CS-163-RP-01	L-CS-163-RP-02	---	---	---
164	---	---	---	---	---
165	L-CS-163-RP-01	L-CS-163-RP-02	L-CS-163-RP-01	---	---
166	L-CS-168-RP-01	---	---	L-CS-172-RP-01	---
167	L-CS-168-RP-01	---	L-CS-172-RP-01	L-CS-172-RP-01	---
168	L-CS-168-RP-01	---	---	---	---
169	L-CS-168-RP-01	---	L-CS-168-RP-01	L-CS-172-RP-01	---
170	L-CS-172-RP-01	---	---	---	L-CS-172-RP-01
171	L-CS-172-RP-01	---	---	---	---
172	L-CS-172-RP-01	---	---	---	---
173	L-CS-172-RP-01	---	---	---	L-CS-172-RP-01
174	L-CS-172-RP-01	---	L-CS-172-RP-01	L-CS-172-RP-01	---
175	L-CS-172-RP-01	---	L-CS-172-RP-01	---	---
176	---	---	---	---	---
177	L-CS-163-RP-01	---	---	---	---
178	---	---	---	---	---
179	L-CS-163-RP-01	---	---	---	---

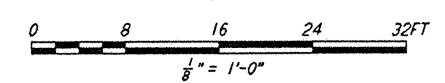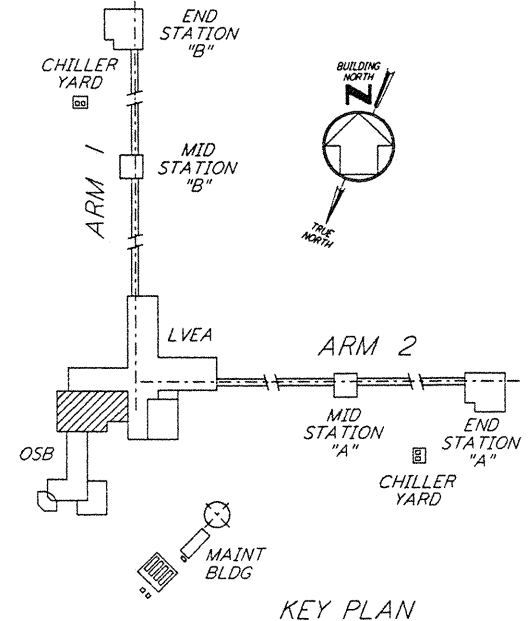

DRAWING NO.	DESCRIPTION	NO.	DATE	BY	CHKD	ENGR	PROJ	DESCRIPTION

ISSUED FOR CONSTRUCTION		
DRAWN	M.M.	11-15-96
CHECKED	JCL	7-24-96
ENGINEER	WCL	10-25-96
PROJ	2078	11/17/96

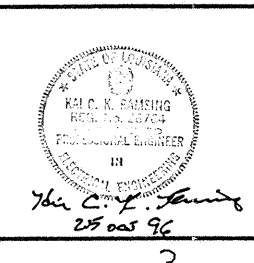

PARSONS
100 WEST WALNUT STREET
PASADENA, CALIFORNIA

LIGO
CALIFORNIA INSTITUTE OF TECHNOLOGY
MASSACHUSETTS INSTITUTE OF TECHNOLOGY

LASER INTERFEROMETER
GRAVITATIONAL-WAVE OBSERVATORY
SITE NO. 2 - LIVINGSTON, LOUISIANA

TITLE: ELECTRICAL CORNER STATION OSB LAB AREA RECEPTACLE & POWER PLAN

SCALE: AS NOTED

PROJECT NUMBER: PP150969

SHEET NUMBER: 8094

SHEET NUMBER: LA-E-106