



NOTES:
1. SEE SHEET RG-C-002 FOR GENERAL NOTES, LEGEND AND ABBREVIATIONS.


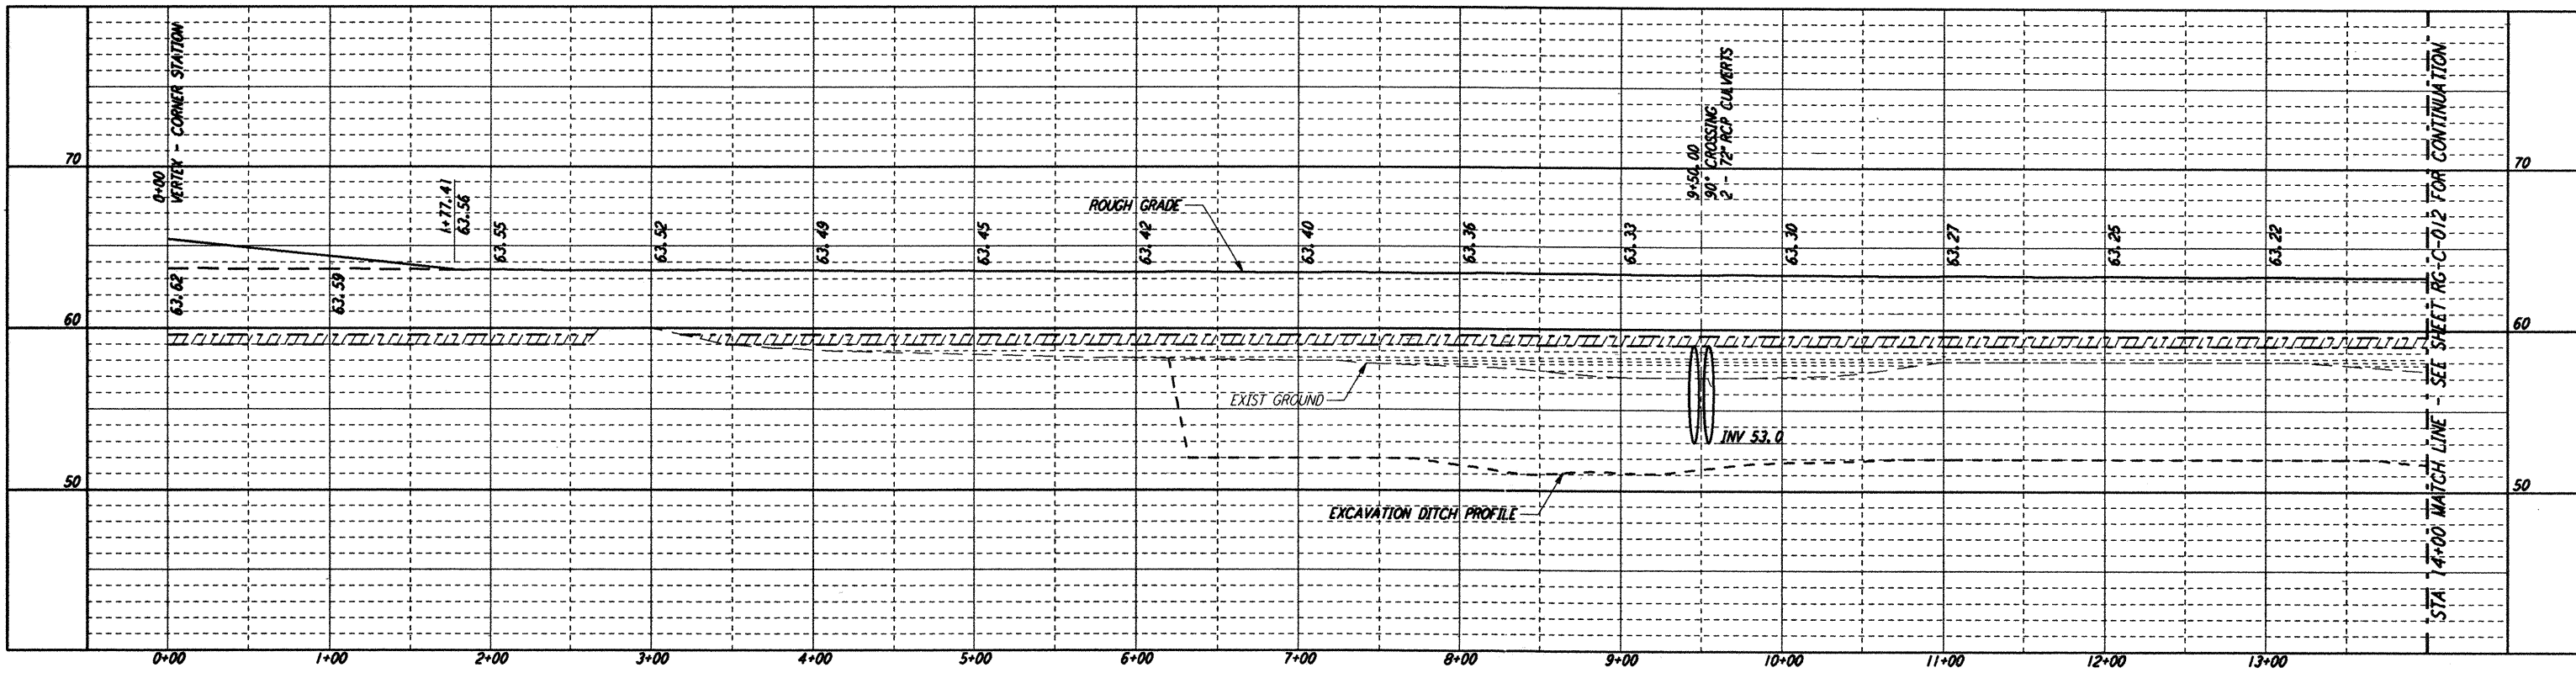


CURVE DATA				
Δ	RADIUS	LENGTH	TANGENT	
4	90°00'00"	35.00'	54.98'	35.00'
5	90°00'00"	50.00'	78.54'	50.00'
6	45°00'00"	100.00'	78.54'	41.42'
7	90°00'00"	25.00'	39.27'	25.00'

PROFILE
SCALE: HORIZ: 1" = 50'
VERT: 1" = 5'

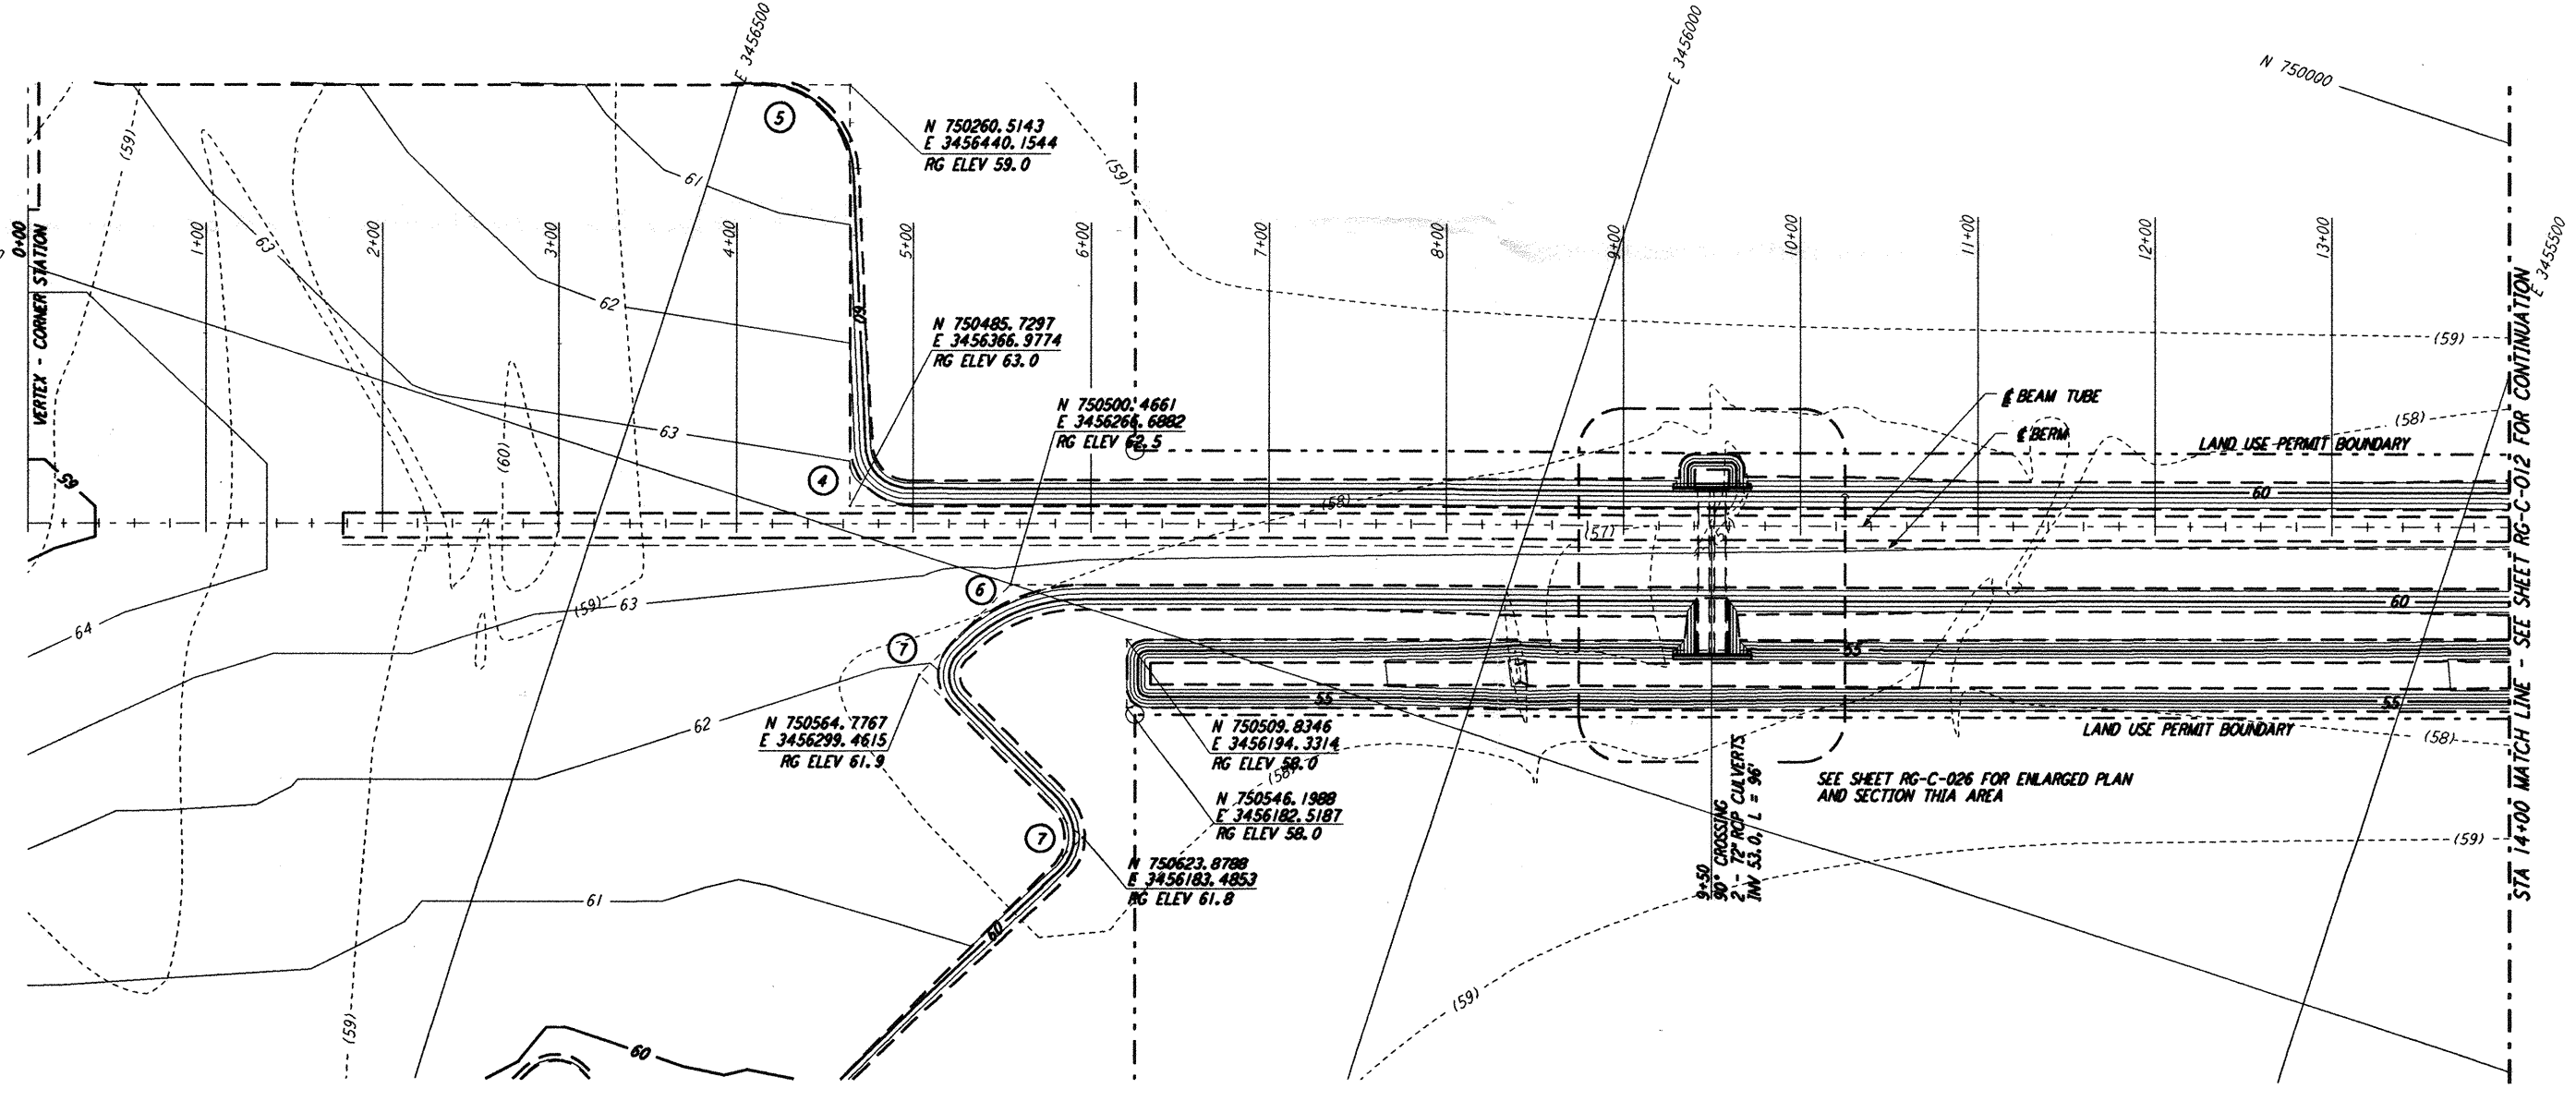

PLAN
SCALE: 1" = 50'

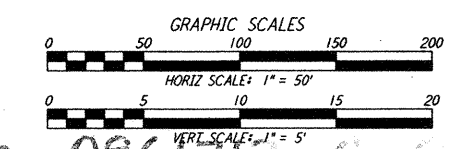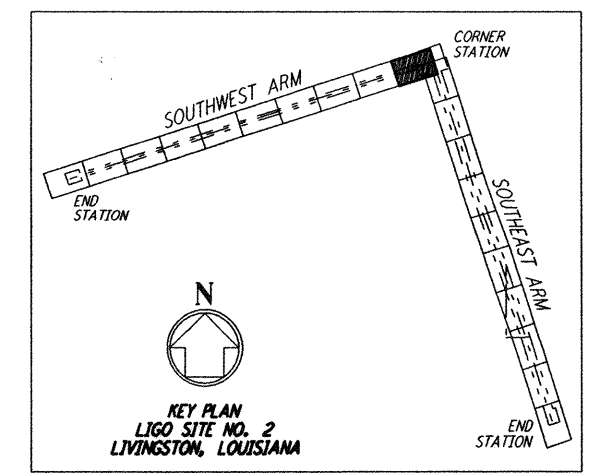

LIGO - 0961711 - A - 1

LASER INTERFEROMETER GRAVITATIONAL-WAVE OBSERVATORY ROUGH GRADING - LIVINGSTON, LA

TITLE: **ROUGH GRADING SOUTHWEST ARM PLAN AND PROFILE STA 0+00 TO STA 14+00**

SCALE: AS NOTED

CONTRACT NUMBER: **PP150969**

PROJECT NUMBER: **8094**

SHEET NUMBER: **RG-C-011**

PARSONS

100 WEST WALNUT STREET
PASADENA, CALIFORNIA

LIGO

CALIFORNIA INSTITUTE OF TECHNOLOGY
MASSACHUSETTS INSTITUTE OF TECHNOLOGY

NO.	DATE	APRD BY	DESCRIPTION OF REVISION
9			
8			
7			
6			
5			
4			
3			
2			
1			

NO.	DATE	APRD BY	JOB	ISSUED FOR
1	8/11/95		FINAL DESIGN REVIEW	

This document and the design it covers are the property of PARSONS. They are loaned only with the borrower's expressed written agreement that they will not be reproduced, copied, loaned, exhibited, or used in any other way, except by written consent from PARSONS to the borrower.