

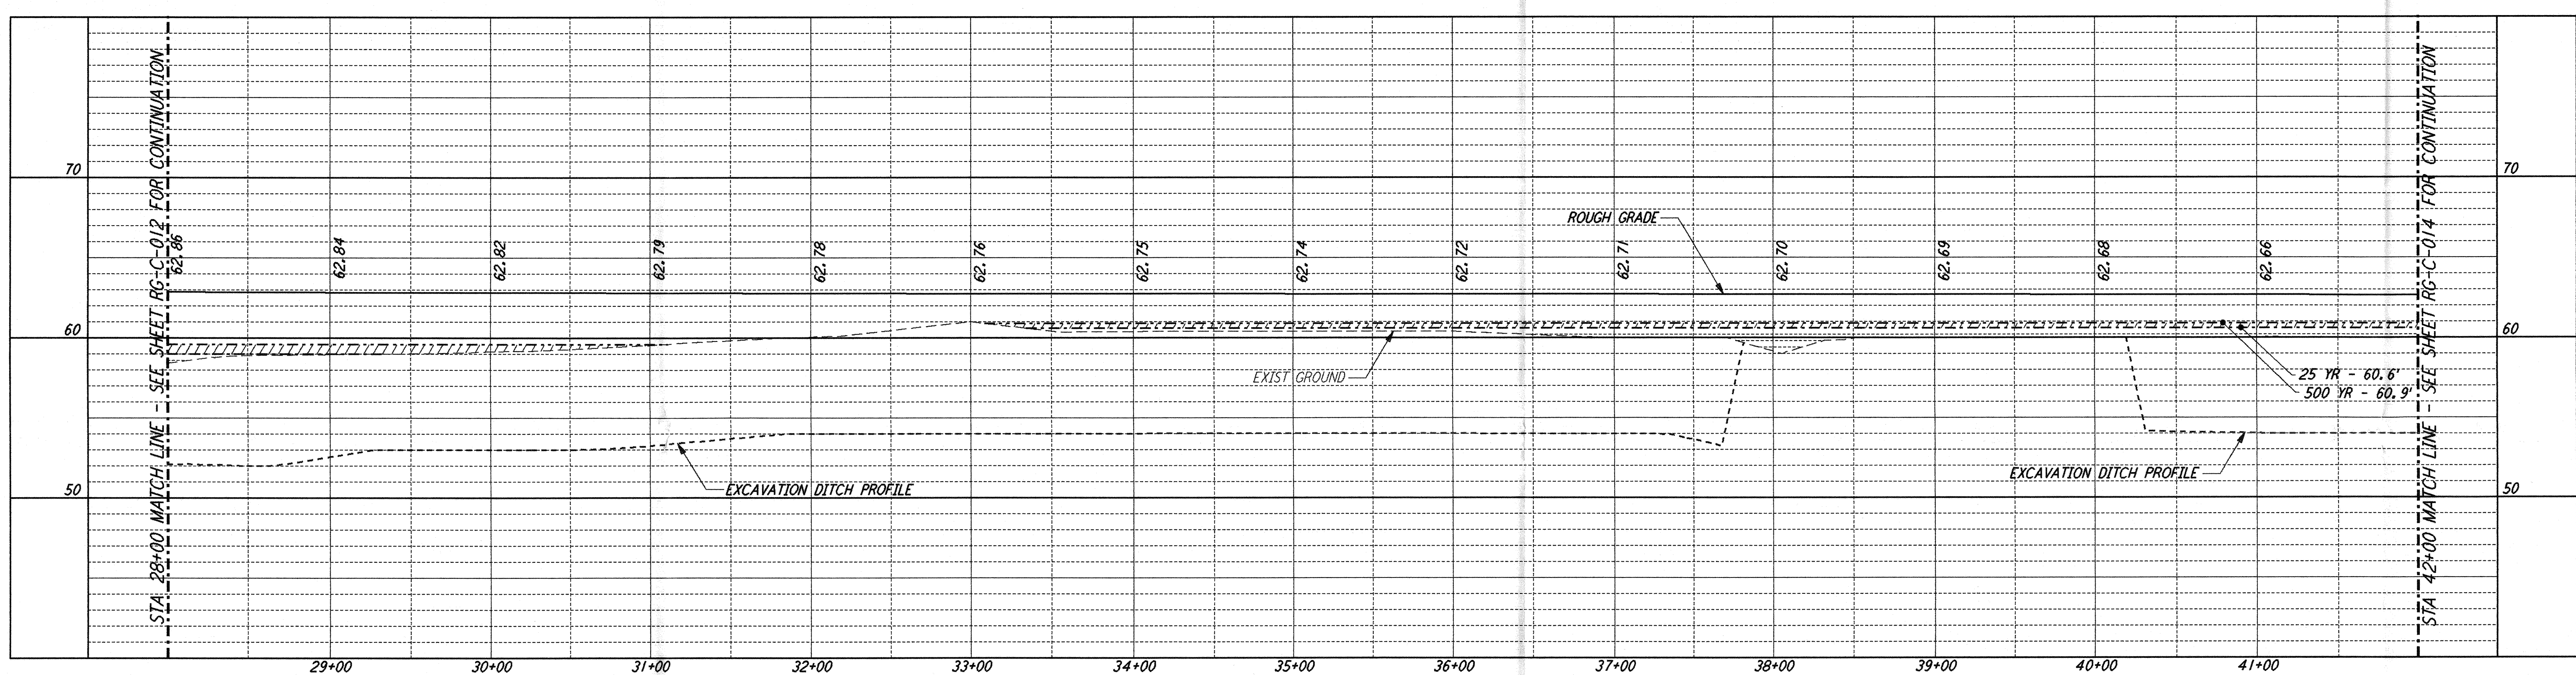


NOTES:
1. SEE SHEET RG-C-002 FOR GENERAL NOTES, LEGEND AND ABBREVIATIONS.


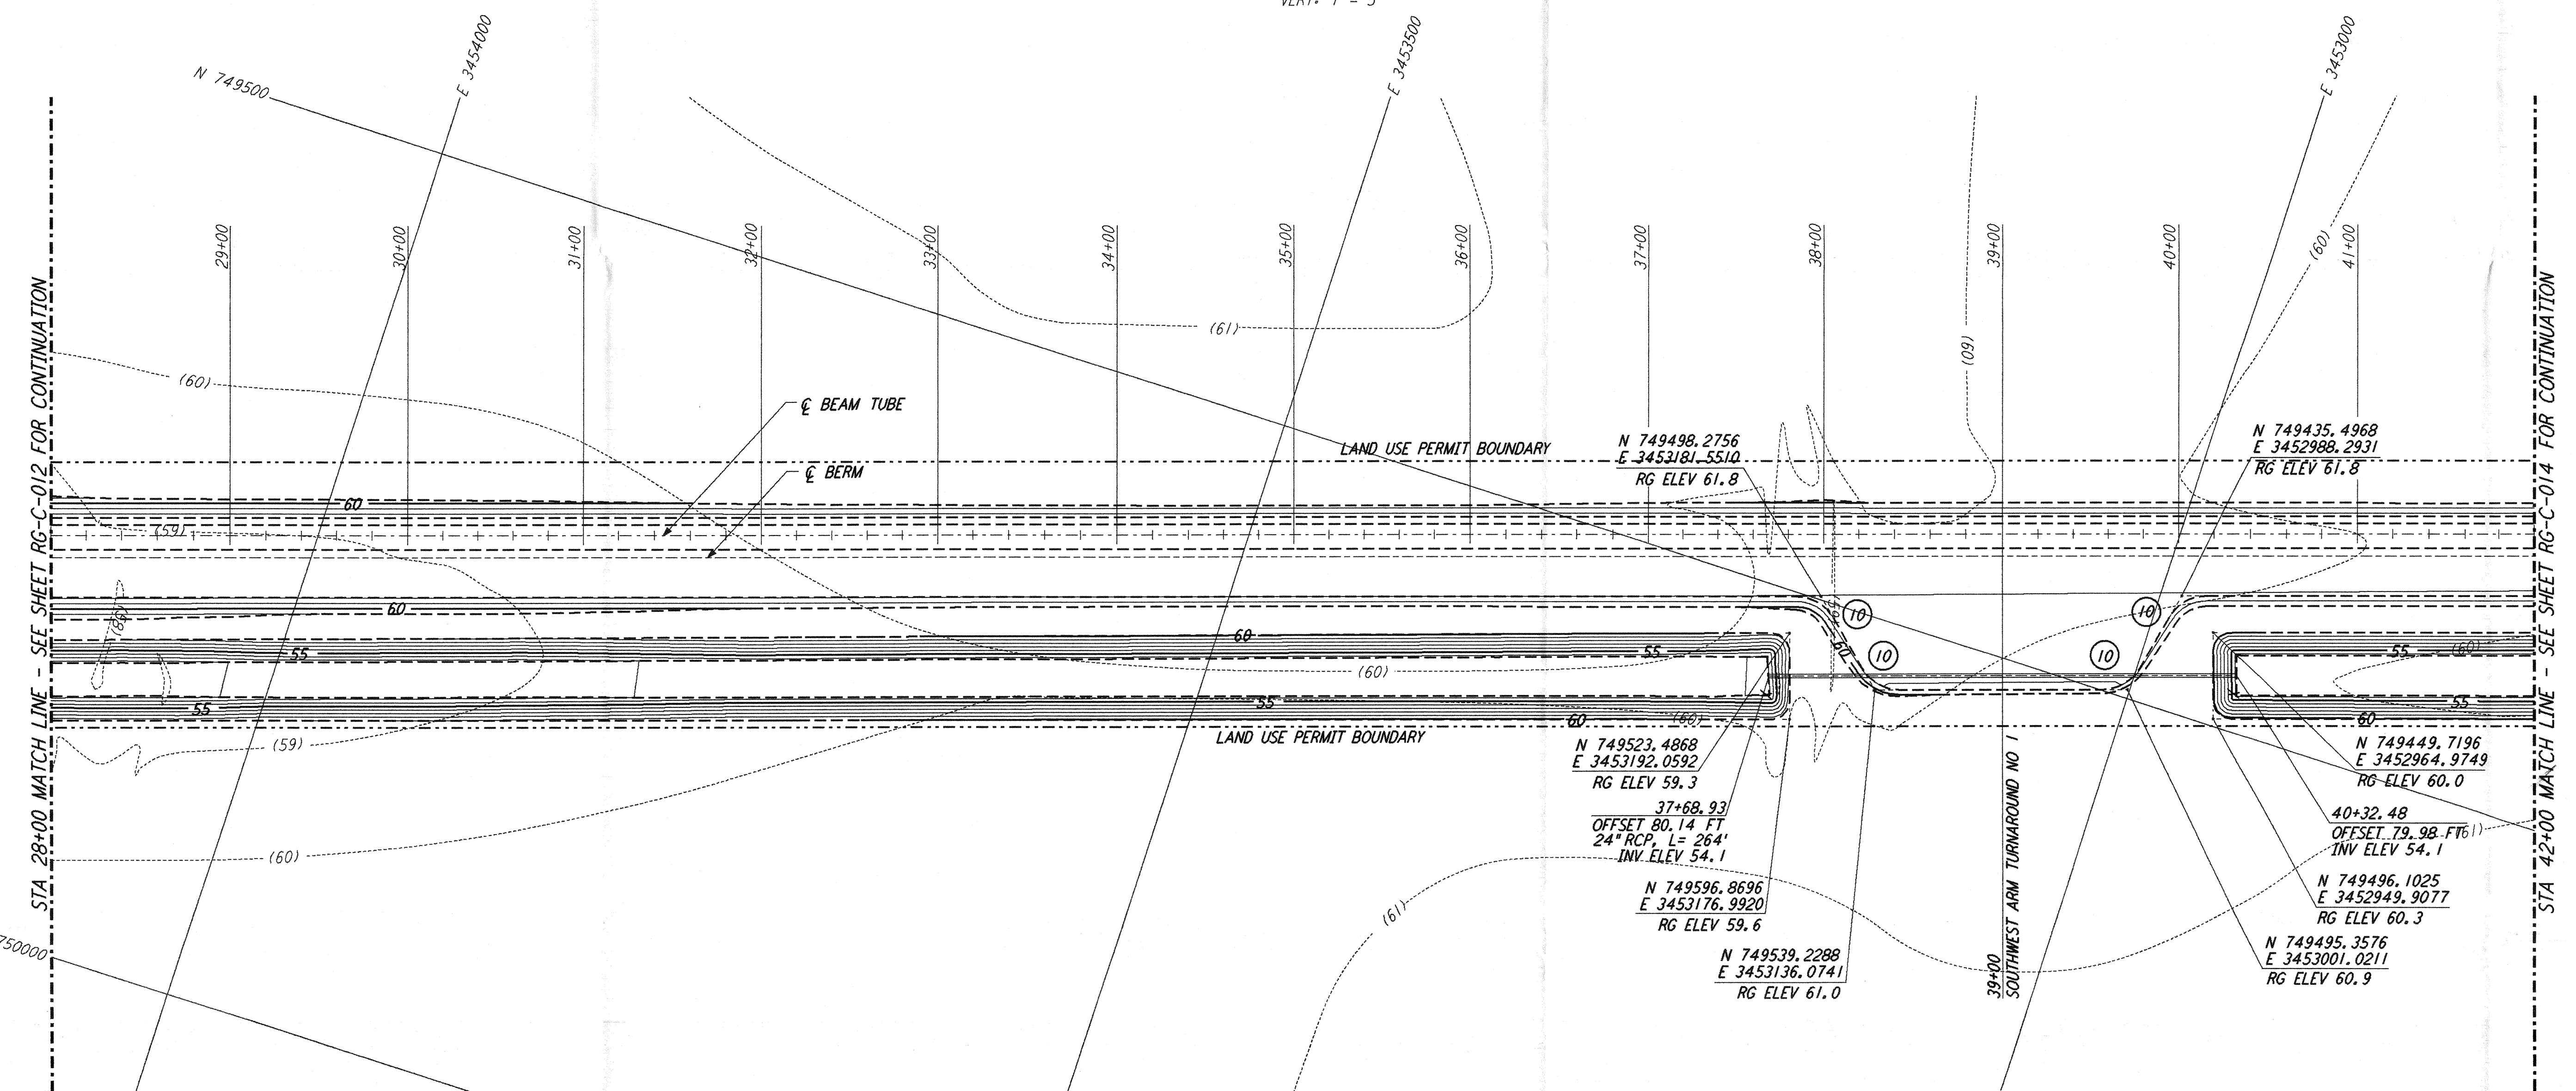


Δ	RADIUS	LENGTH	TANGENT
10	60°00'00"	25.00'	26.18'
			14.43'

PROFILE
SCALE: HORIZ: 1" = 50'
VERT: 1" = 5'

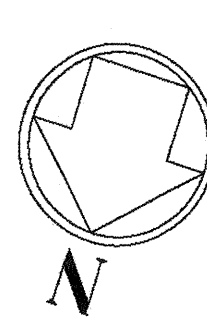

PLAN
SCALE: 1" = 50'

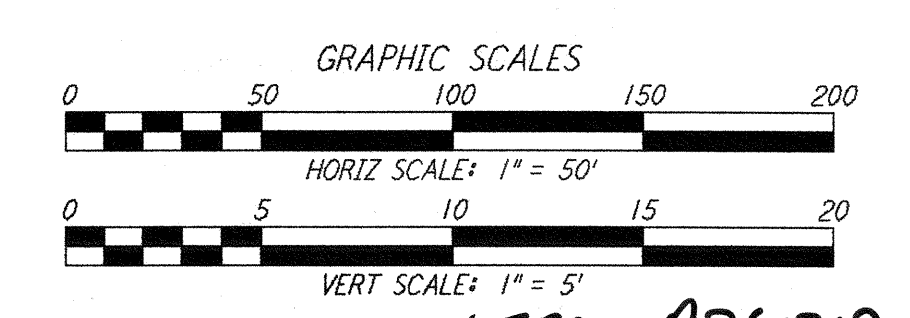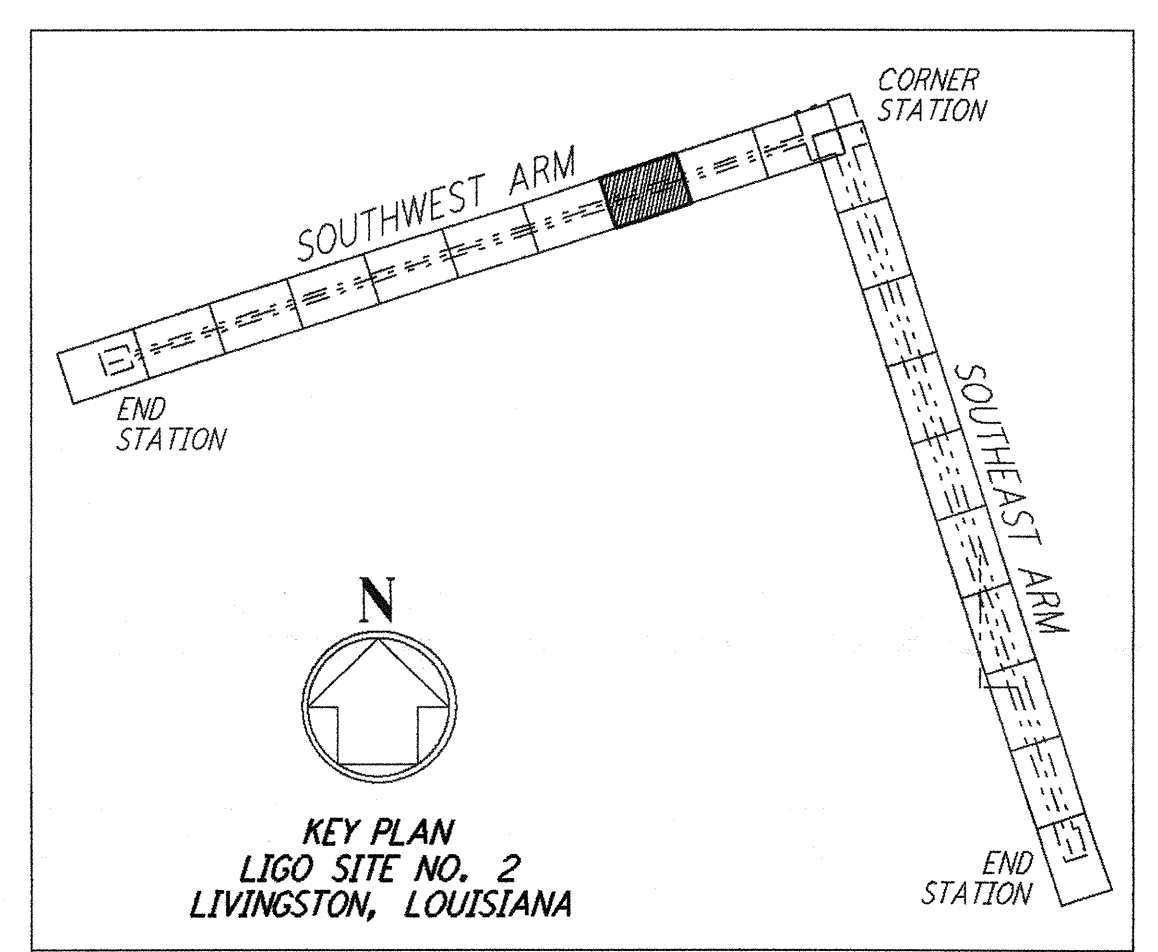

NO.	DATE	APRD BY	DESCRIPTION OF REVISION
9			
8			
7			
6			
5			
4			
3			
2			
1			

NO.	DATE	APRD BY	ISSUED FOR
1	8/11/95	JUB	FINAL DESIGN REVIEW

DATE	8/11/95
DRAWN	WRB
CHECKED	MGP
SECT HD	MGP
PROJ MGR	
CLIENT	

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MASSACHUSETTS INSTITUTE OF TECHNOLOGY

LASER INTERFEROMETER
GRAVITATIONAL-WAVE OBSERVATORY
ROUGH GRADING - LIVINGSTON, LA

TITLE	AS NOTED	CONTRACT NUMBER	PROJECT NUMBER
ROUGH GRADING SOUTHWEST ARM PLAN AND PROFILE STA 28+00 TO STA 42+00	PP150969	8094	
SHEET NUMBER	REVISIONS		
RG-C-013			

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