




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NOTES:
 1. SEE SHEET RG-C-002 FOR GENERAL NOTES, LEGEND AND ABBREVIATIONS.



CURVE DATA				
Δ	RADIUS	LENGTH	TANGENT	

PROFILE
 SCALES: HORIZ: 1" = 50'
 VERT: 1" = 5'

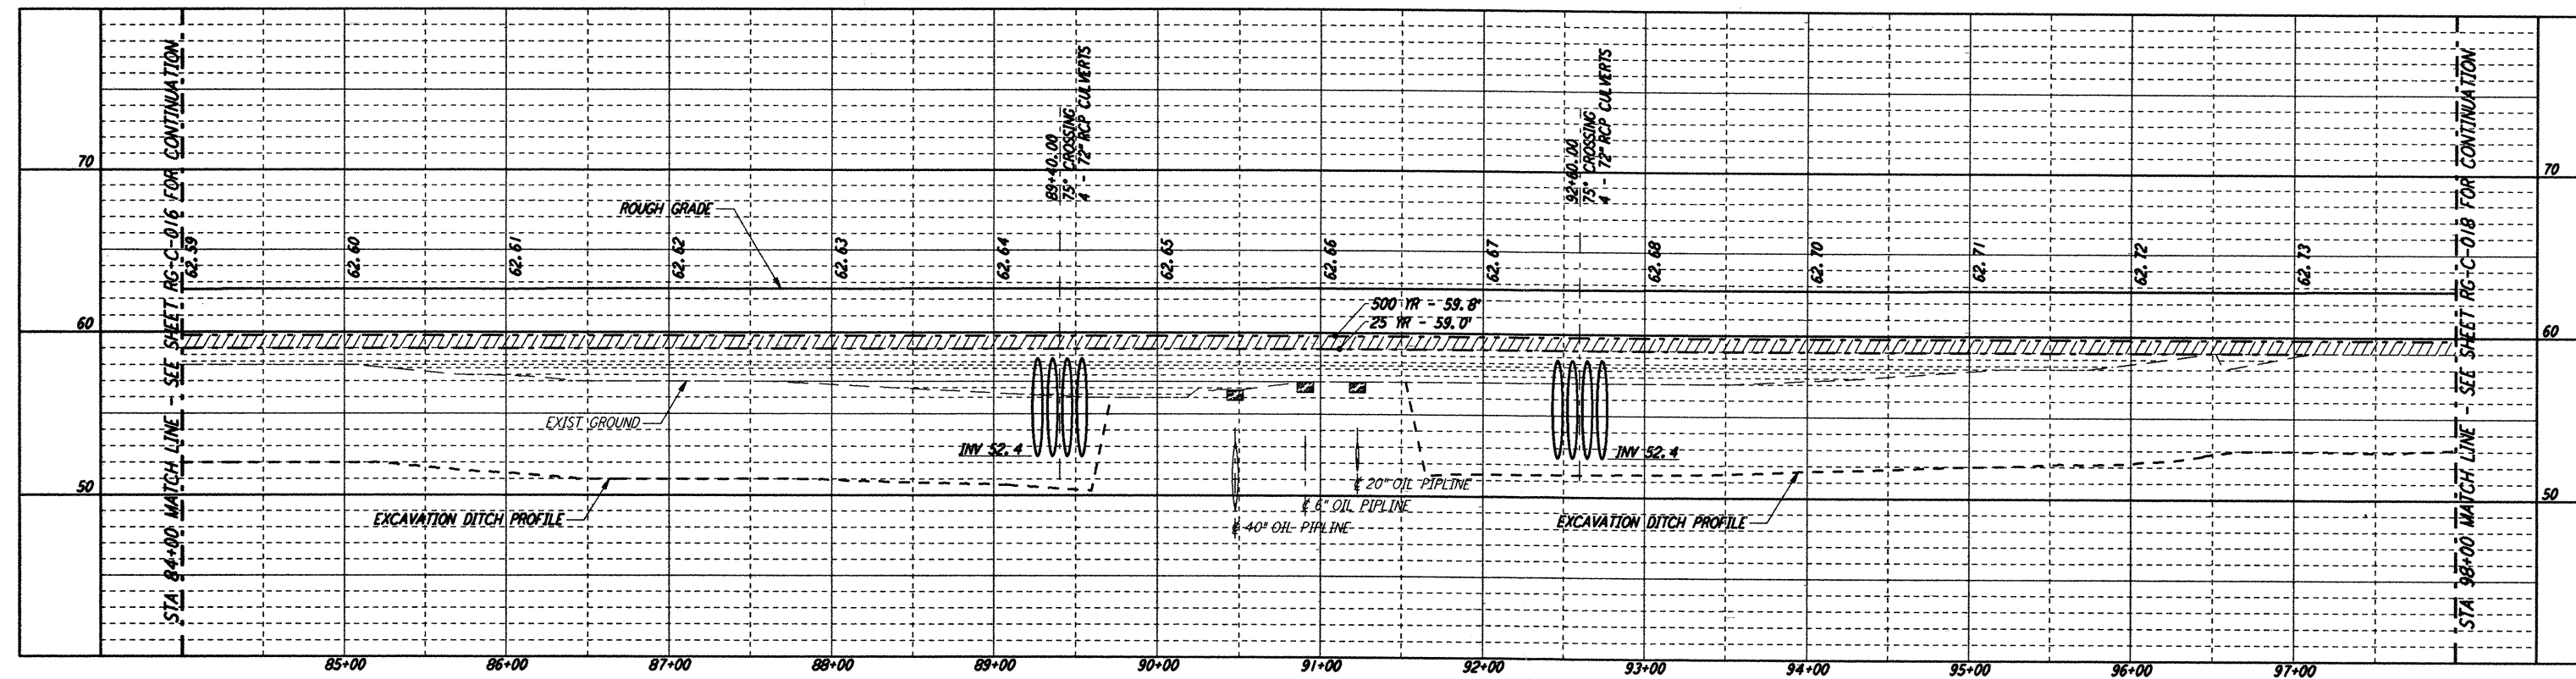

PLAN
 SCALE: 1" = 50'

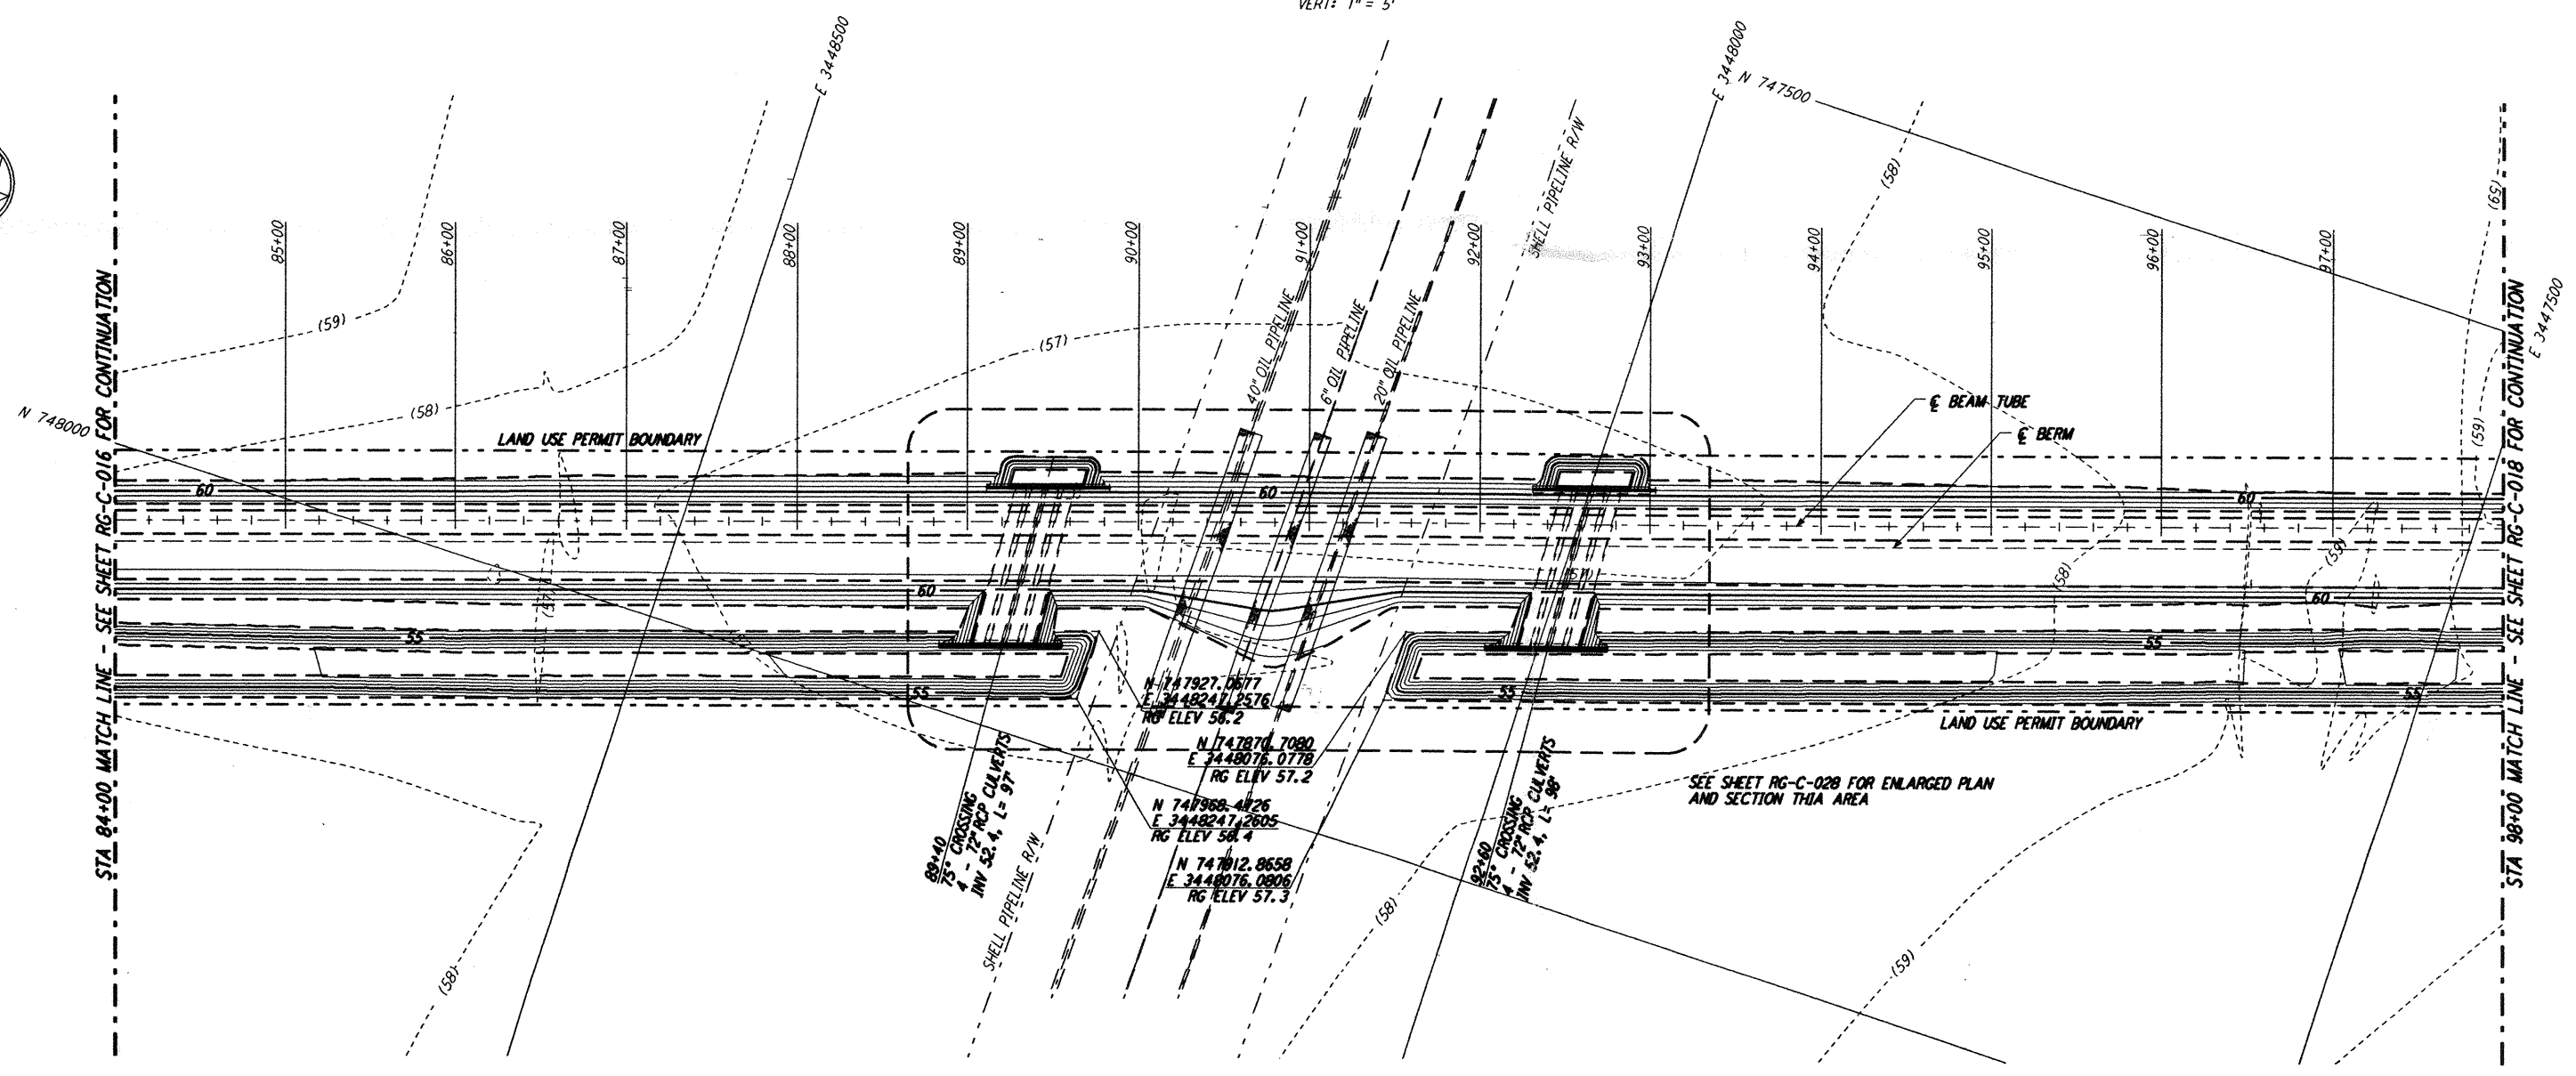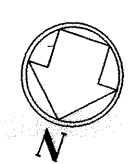NOTE:
 LIGO SOUTHWEST ARM CROSSING OF SHELL PIPELINE R/W OCCURS WITHIN LIVINGSTON PARRISH, LOUISIANA, TOWNSHIP 6 SOUTH - RANGE 4 EAST, SECTION 3.

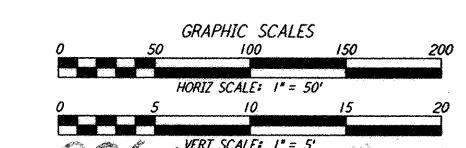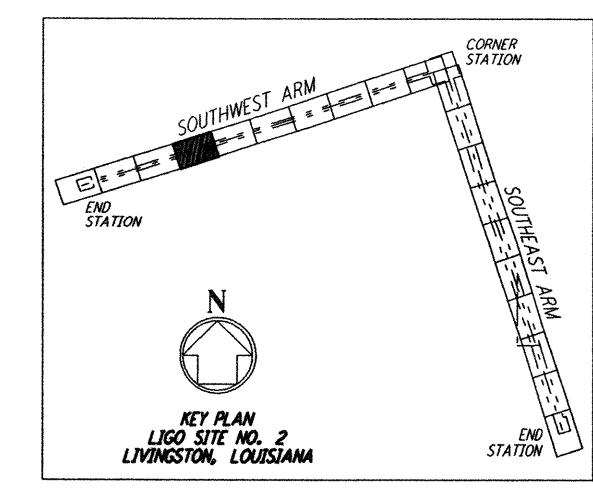

NO.	DATE	APPRO BY	DESCRIPTION OF REVISION

DATE	BY	DESCRIPTION
8/11/95	JLB	FINAL DESIGN REVIEW

PARSONS
 100 WEST WALNUT STREET
 PASADENA, CALIFORNIA

LIGO
 CALIFORNIA INSTITUTE OF TECHNOLOGY
 MASSACHUSETTS INSTITUTE OF TECHNOLOGY

**LASER INTERFEROMETER
 GRAVITATIONAL-WAVE OBSERVATORY
 ROUGH GRADING - LIVINGSTON, LA**

TITLE: **ROUGH GRADING SOUTHWEST ARM PLAN AND PROFILE STA 84+00 TO STA 98+00**
 AS NOTED: **PP150969**
 SHEET NUMBER: **RG-C-017**
 PROJECT NUMBER: **8094**