


not be reproduced, copied, loaned, exhibited, or used in any other way, except by written consent from PARSONS to the borrower.


This document and the design it covers are the property of PARSONS. They are loaned only with the borrower's expressed written agreement that they will

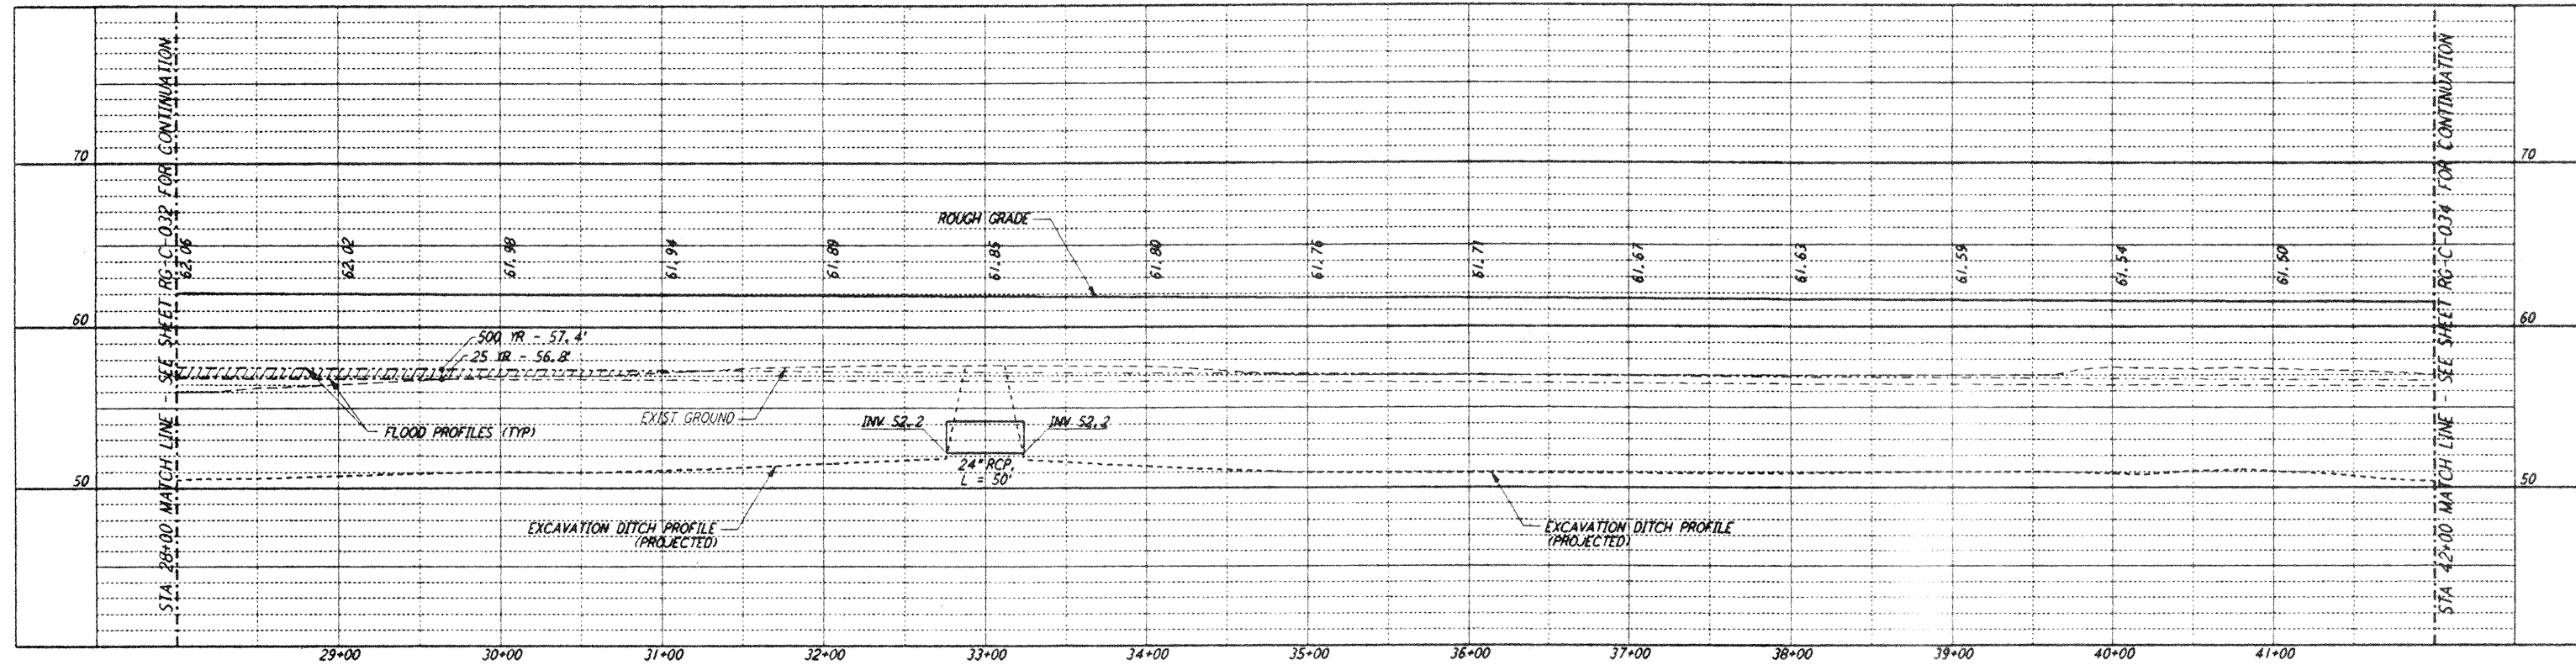



NOTES:
 1. SEE SHEET RG-C-002 FOR GENERAL NOTES, LEGEND AND ABBREVIATIONS.

CURVE DATA				
Δ	RADIUS	LENGTH	TANGENT	
10	60°00'00"	25.00'	26.18'	14.43'

PROFILE
 SCALES: HORIZ: 1" = 50'
 VERT: 1" = 5'

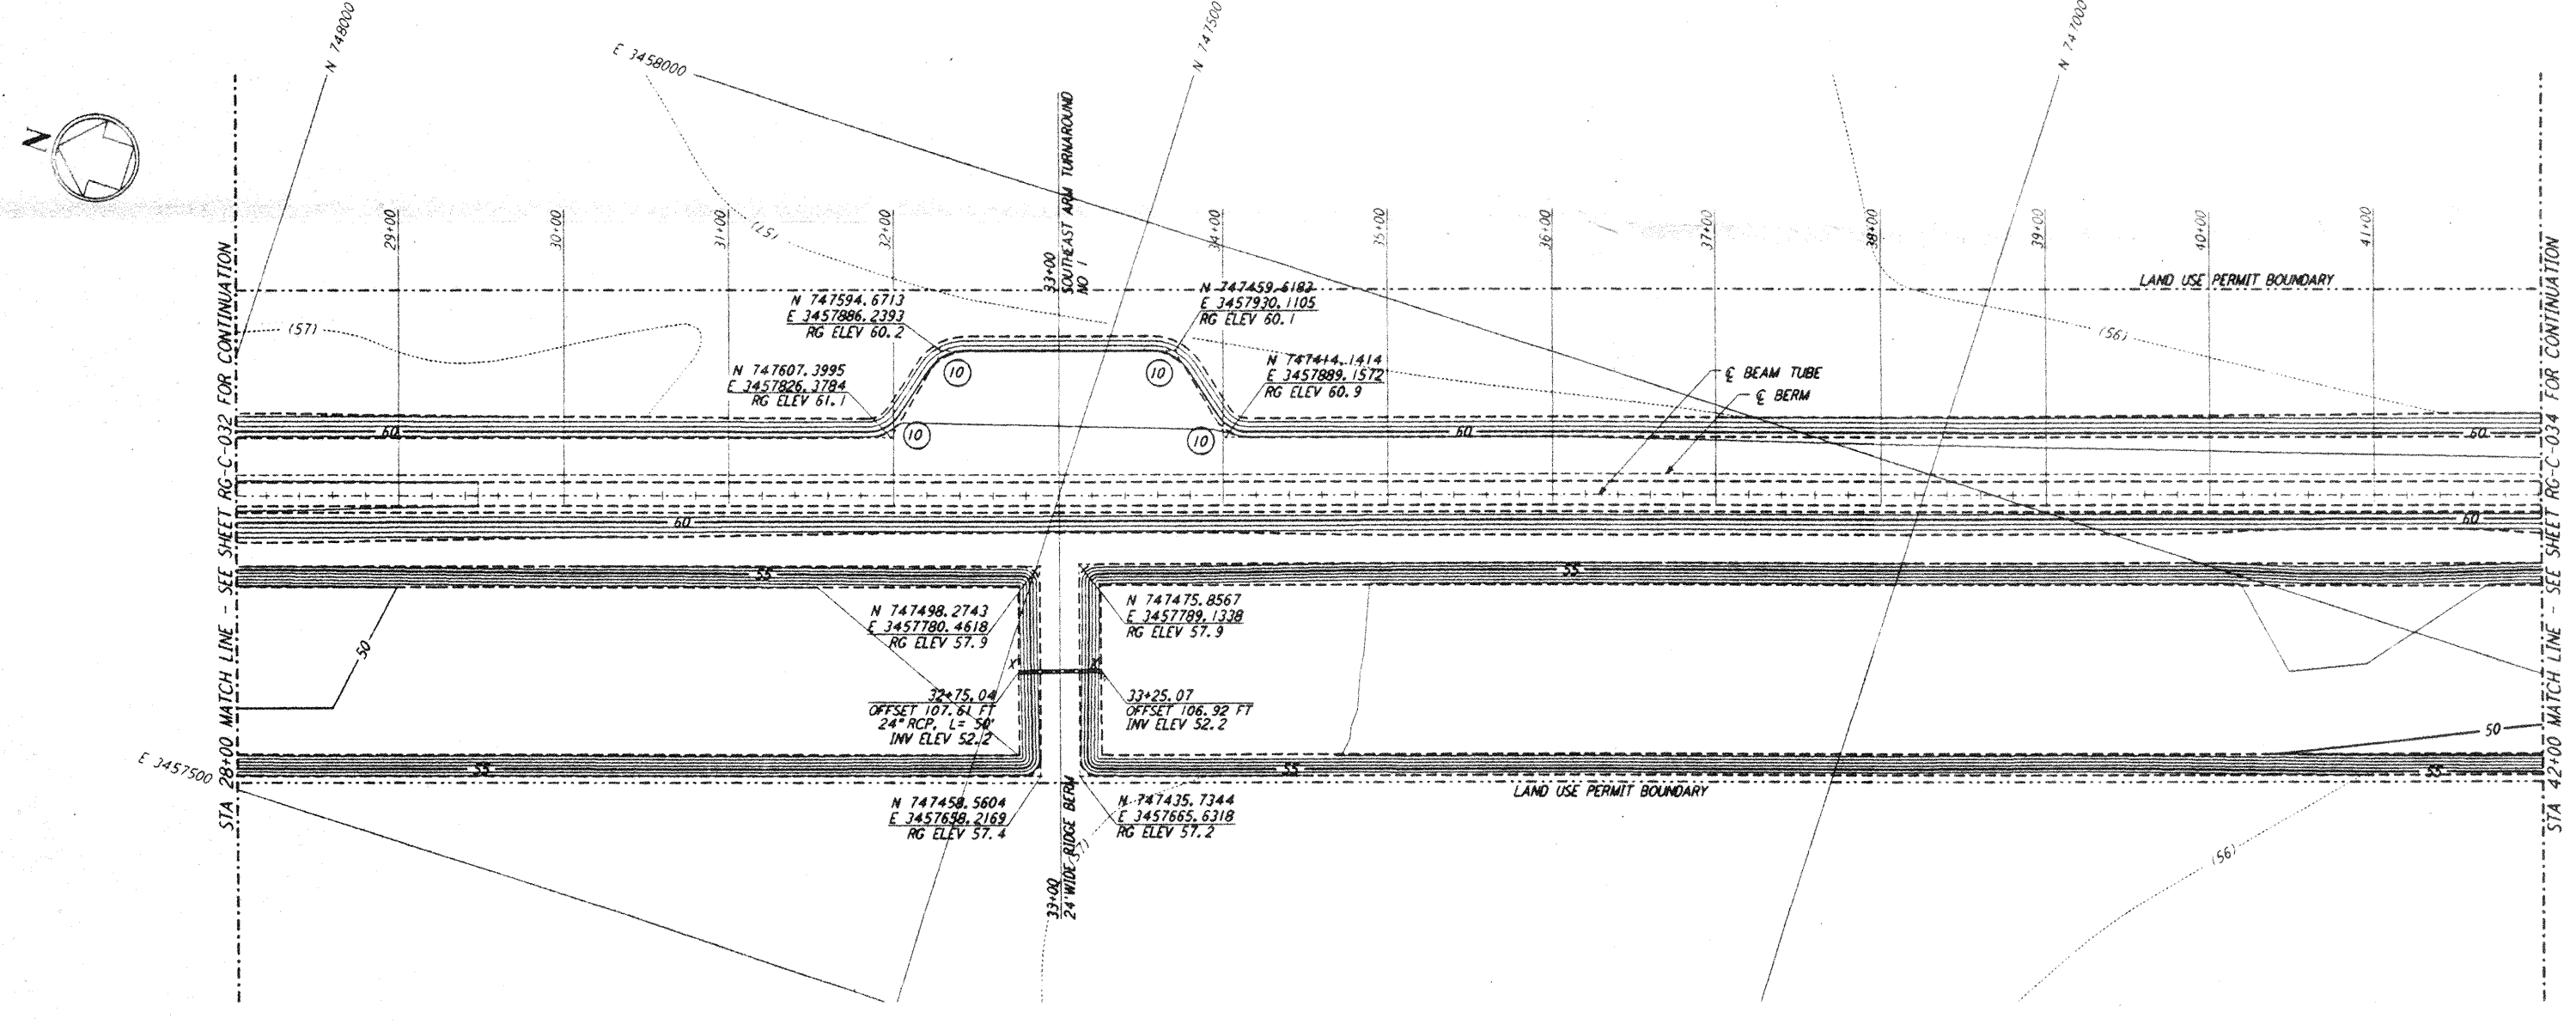


PLAN
 SCALE: 1" = 50'

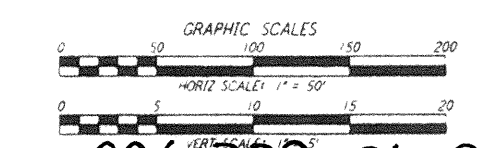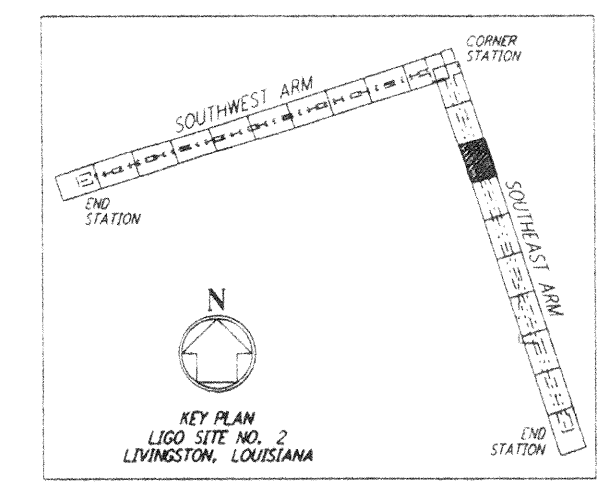

LIGO-0961738-01-0

NO.	DATE	APPRO BY	DESCRIPTION OF REVISION
1	11/1/95	Tom	NO REVISIONS
2	11/1/95	Tom	ISSUED FOR CONSTRUCTION
3	8/28/95	Tom	ISSUED FOR BID

DATE	BY	ISSUED FOR
8/11/95	WRB	
8/9/95	MGP	
8/28/95	WRB	
8/28/95	WRB	

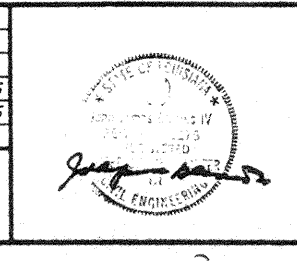

PARSONS
 100 WEST WALNUT STREET
 PASADENA, CALIFORNIA

LIGO
 CALIFORNIA INSTITUTE OF TECHNOLOGY
 MASSACHUSETTS INSTITUTE OF TECHNOLOGY

LASER INTERFEROMETER
 GRAVITATIONAL-WAVE OBSERVATORY
 ROUGH GRADING - LIVINGSTON, LA

TITLE	ROUGH GRADING SOUTHEAST ARM PLAN AND PROFILE	AS NOTED	PP150969	8094
SHEET NUMBER	RG-C-033	PROJECT NUMBER		