



NOTES:
1. SEE SHEET RG-C-002 FOR GENERAL NOTES, LEGEND AND ABBREVIATIONS.


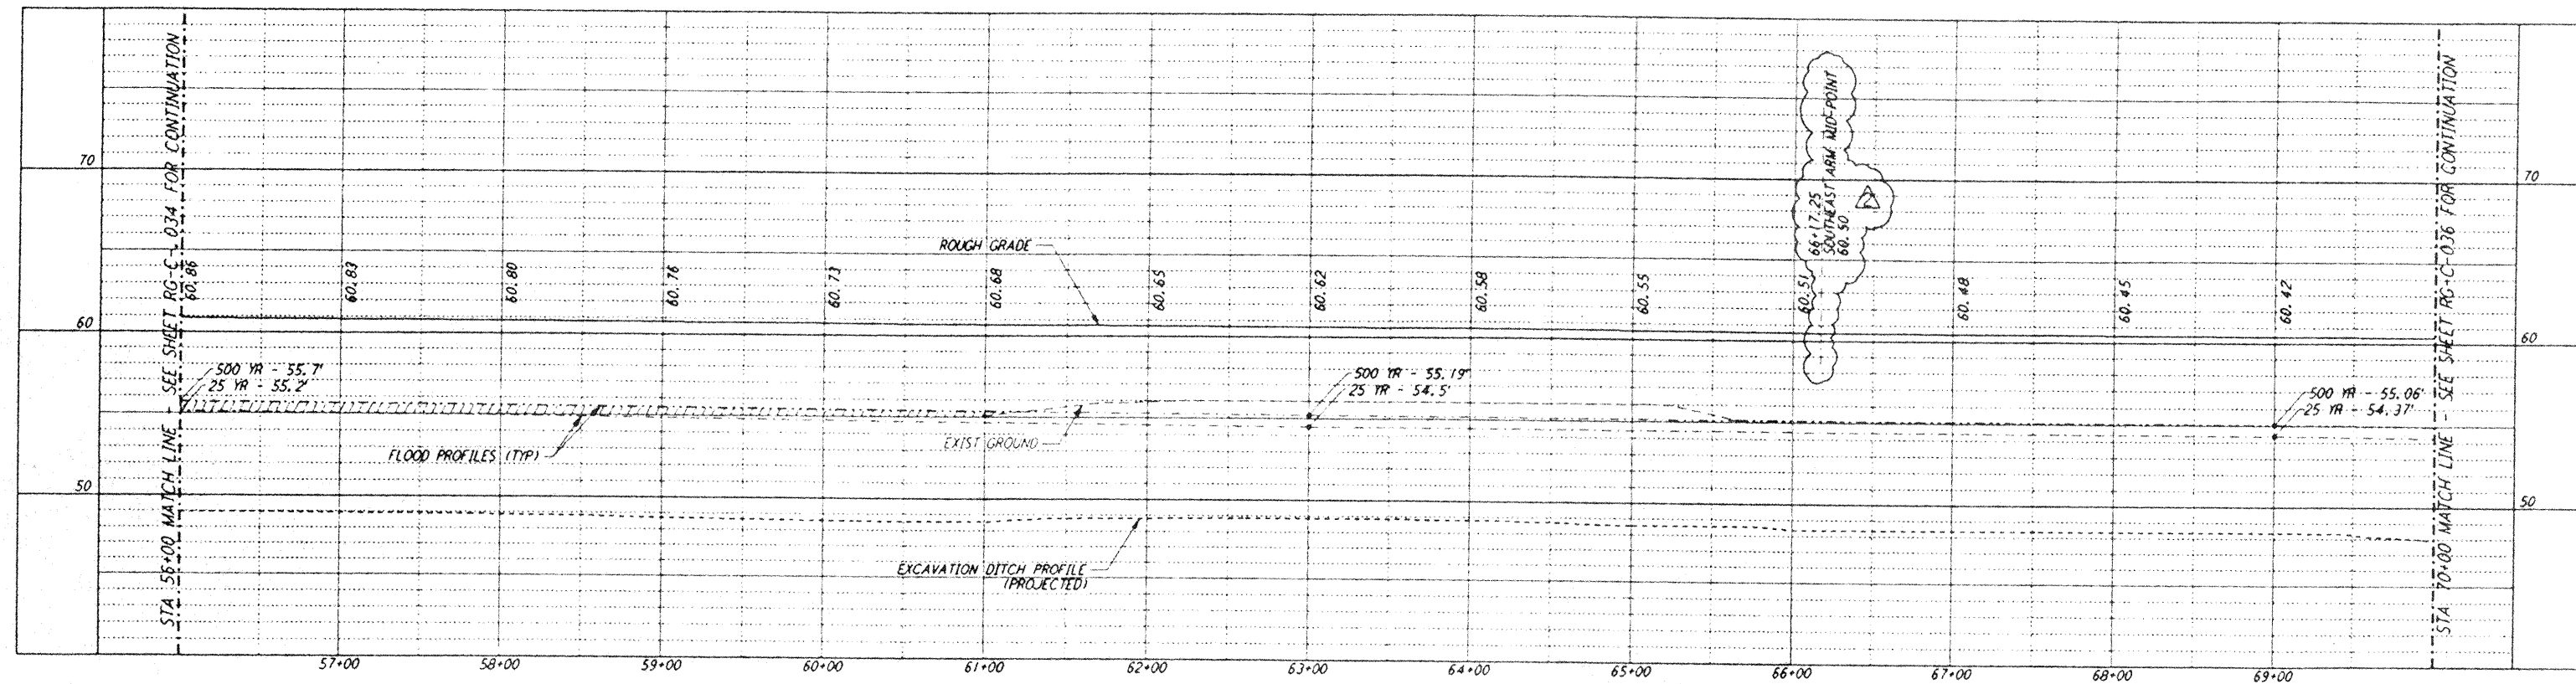


| CURVE DATA | | | | |
|------------|-----------|--------|---------|--------|
| Δ | RADIUS | LENGTH | TANGENT | |
| 11 | 45°00'00" | 39.00' | 30.63' | 16.16' |
| 12 | 45°00'00" | 25.00' | 19.63' | 10.36' |

PROFILE
SCALE: HORIZ. 1" = 50'
VERT. 1" = 5'

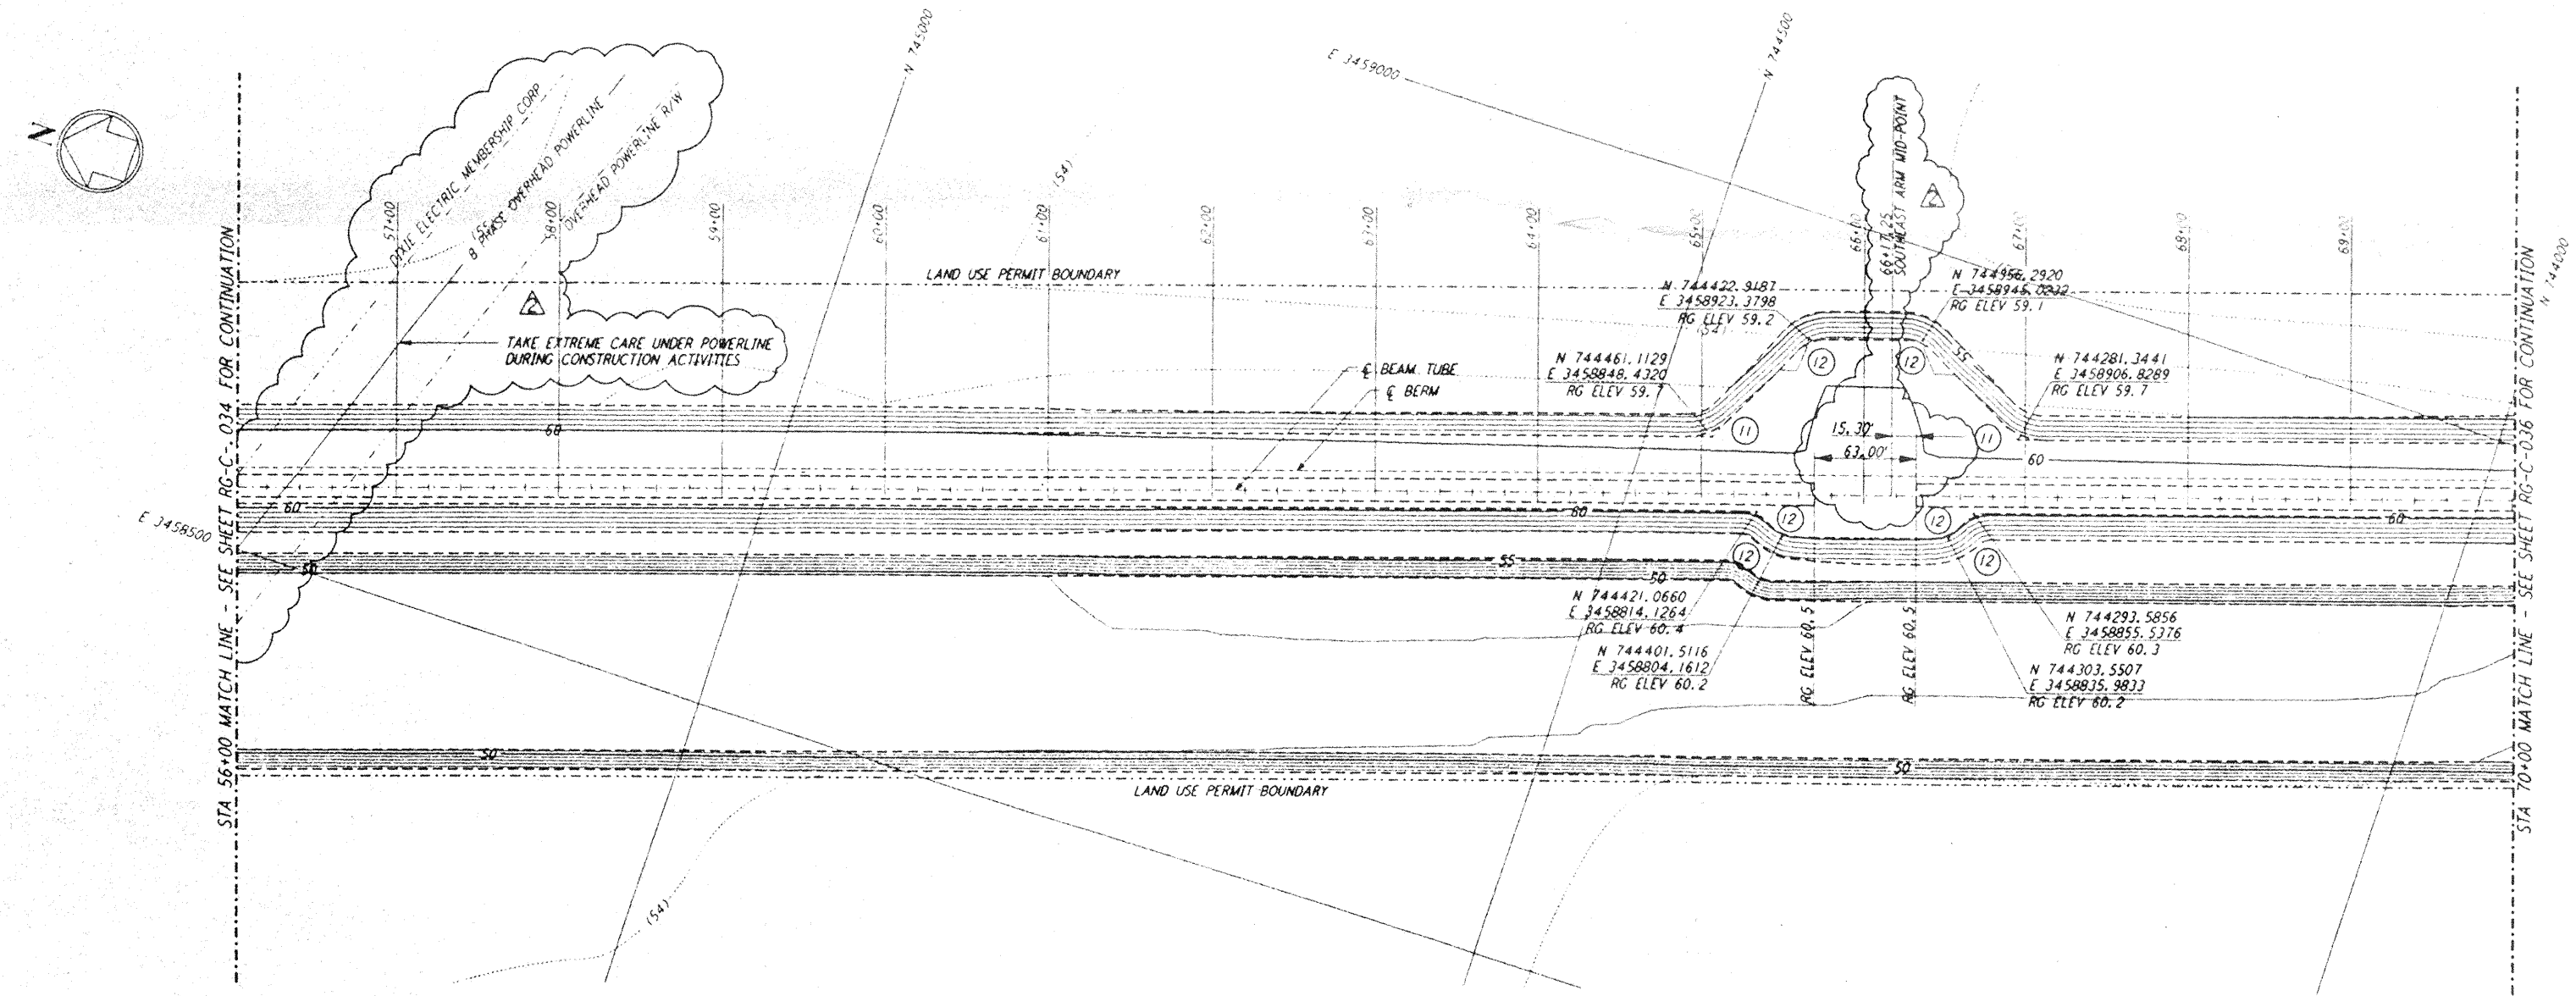

PLAN
SCALE: 1" = 50'

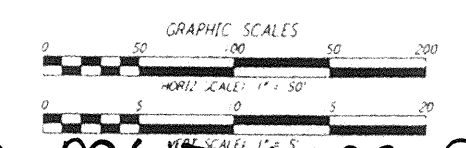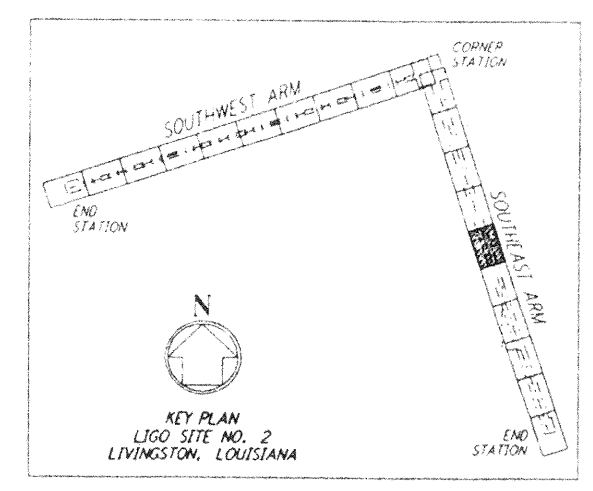

LIGO-0961740-02-0

| NO. | DATE | APPROVED BY | DESCRIPTION OF REVISION | NO. | DATE | APPROVED BY | ISSUED FOR |
|-----|---------|-------------|---|-----|---------|-------------|-------------------------|
| 9 | | | | 4 | | | |
| 8 | | | | 3 | 5/24/96 | Tom | CHANGE ORDER NO. 6 |
| 7 | | | | 2 | 11/1/95 | Tom | ISSUED FOR CONSTRUCTION |
| 6 | | | | 1 | 8/28/95 | Tom | ISSUED FOR BID |
| 5 | | | | | | | |
| 4 | | | | | | | |
| 3 | | | | | | | |
| 2 | 5/24/96 | Tom | REVISED STATION CALLOUT & DIMENSIONS REVISED OVERHEAD POWERLINE RUN LOCATION | | | | |
| 1 | 11/1/95 | Tom | NO REVISIONS | | | | |

DATE: 8/11/95
DRAWN: ARB 8/95
CHECKED: MJP 8/95
ENGINEER: [Signature] 8/28/95
PROJ. MGR: [Signature] 8/28/95

PARSONS
100 WEST WALNUT STREET
PASADENA, CALIFORNIA

LIGO
CALIFORNIA INSTITUTE OF TECHNOLOGY
MASSACHUSETTS INSTITUTE OF TECHNOLOGY

LASER INTERFEROMETER
GRAVITATIONAL-WAVE OBSERVATORY
ROUGH GRADING - LIVINGSTON, LA

ROUGH GRADING
SOUTHEAST ARM
PLAN AND PROFILE
STA 56+00 TO STA 70+00

AS NOTED: PP150969 8094
REVISIONS: 2
PROJECT NUMBER: RG-C-035

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