



NOTES:
1. SEE SHEET RG-C-002 FOR GENERAL NOTES, LEGEND AND ABBREVIATIONS.


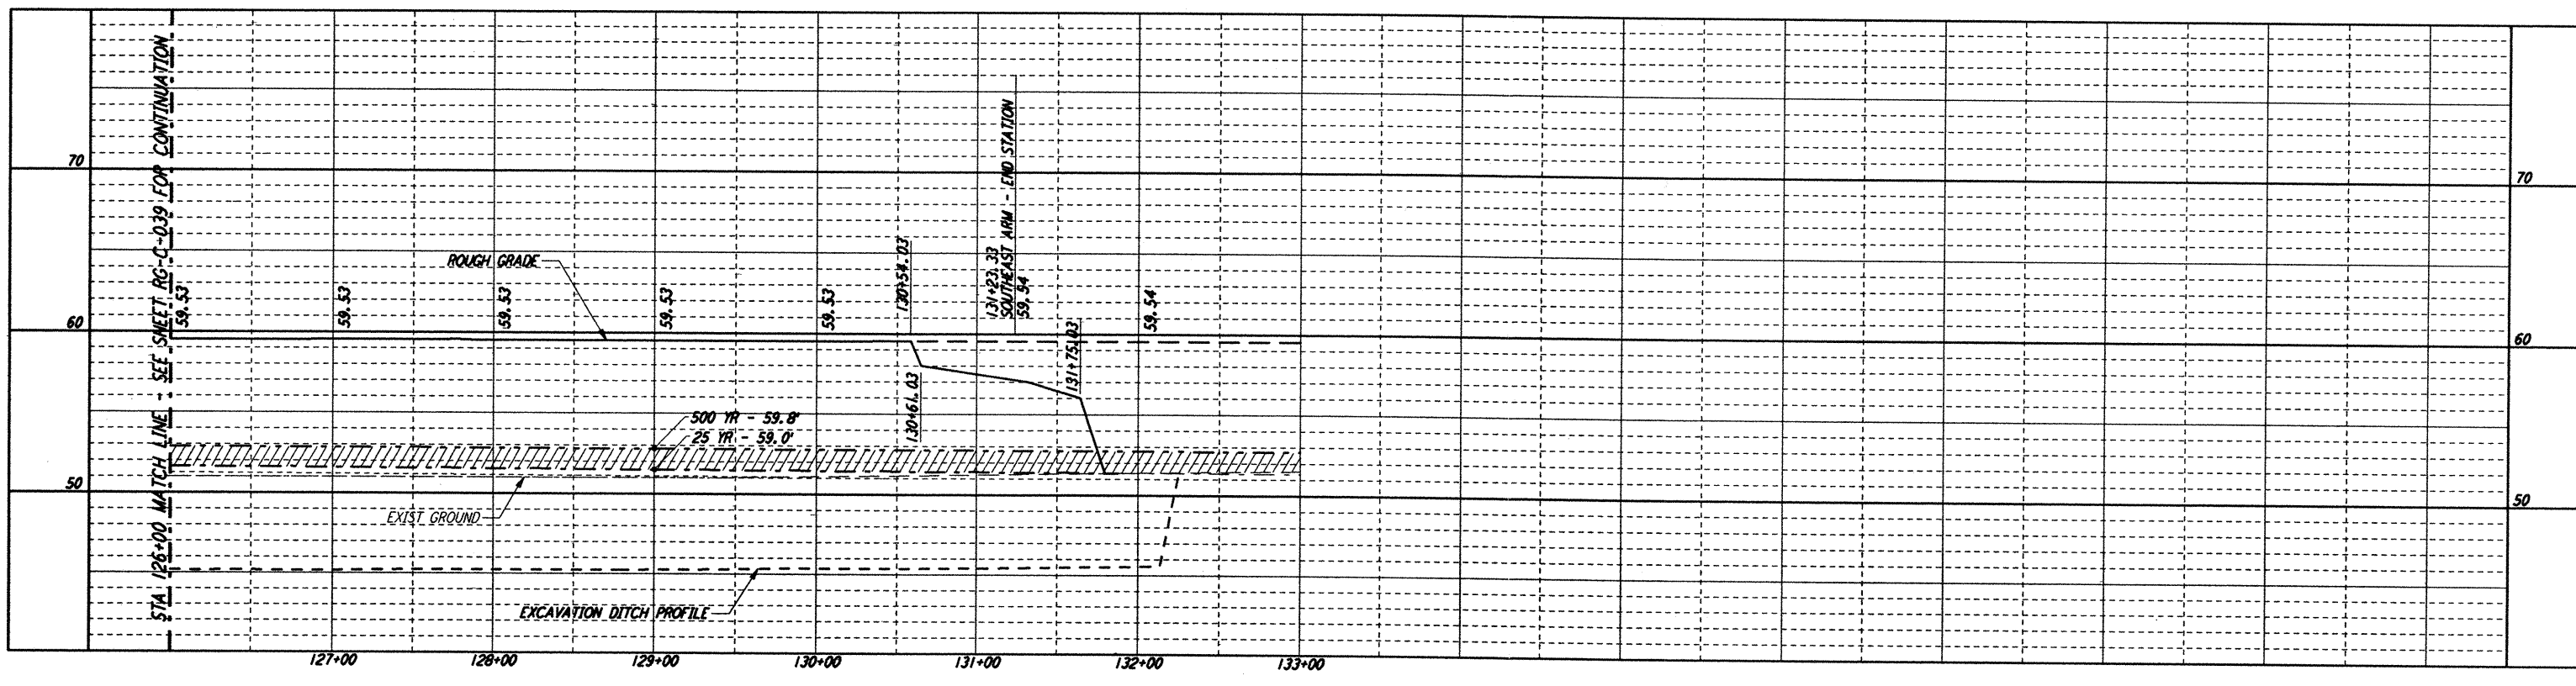


CURVE DATA				
Δ	RADIUS	LENGTH	TANGENT	
7	90°00'00"	25.00'	39.27'	25.00'
11	45°00'00"	39.00'	30.63'	16.16'
13	45°00'00"	81290'	63.62'	33.55'
14	46°23'52"	25.00'	20.24'	10.17'

PROFILE
SCALE: HORIZ: 1" = 50'
VERT: 1" = 5'

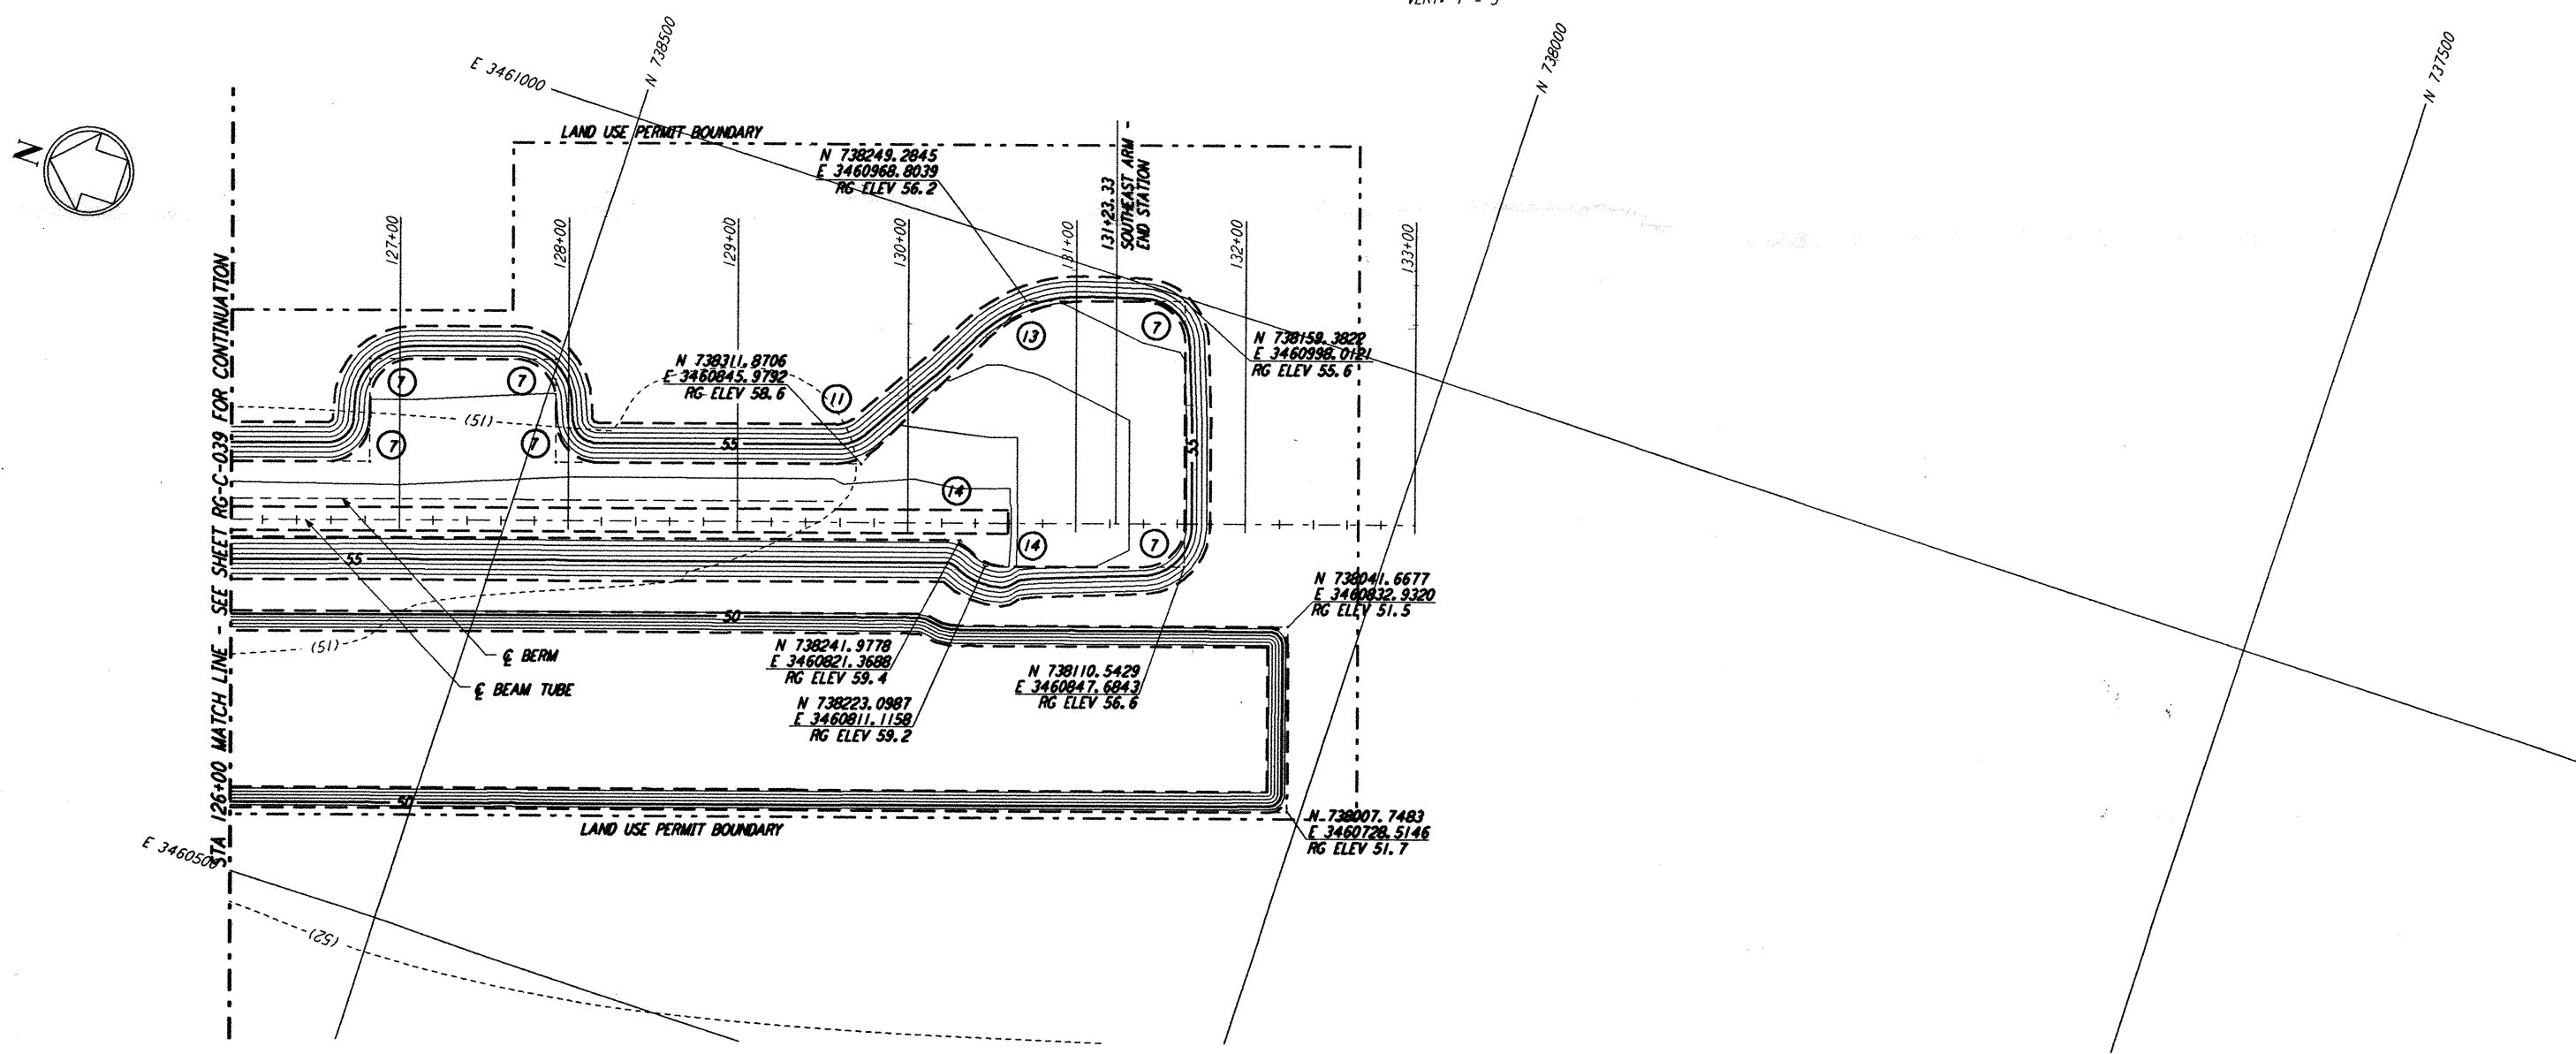

PLAN
SCALE: 1" = 50'

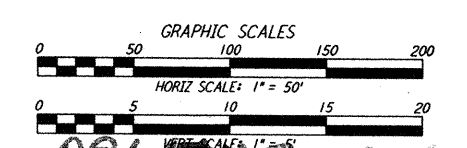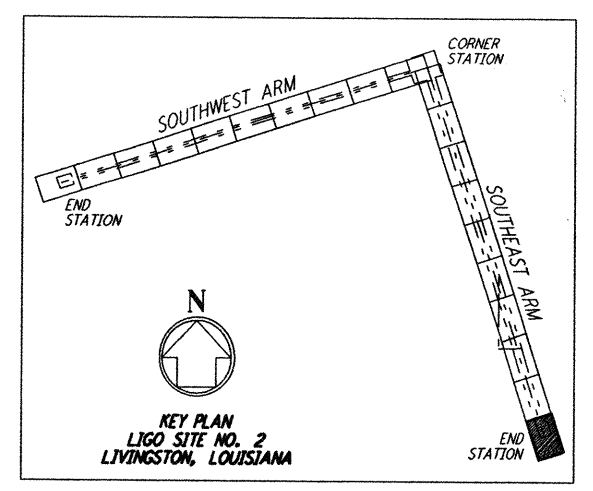

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NO.	DATE	APPROVED BY	DESCRIPTION OF REVISION
1	8/11/95	JUB	FINAL DESIGN REVIEW

DATE	8/11/95
DRAWN	WRB WRS
CHECKED	MGP YHP
SECT HD	
PROJ MGR	
CLIENT	

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PASADENA, CALIFORNIA

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MASSACHUSETTS INSTITUTE OF TECHNOLOGY

**LASER INTERFEROMETER
GRAVITATIONAL-WAVE OBSERVATORY
ROUGH GRADING - LIVINGSTON, LA**

TITLE	ROUGH GRADING SOUTHWEST ARM PLAN AND PROFILE STA 126+00 TO STA 133+00	SCALE	AS NOTED	CONTRACT NUMBER	PP150969	PROJECT NUMBER	8094
SHEET NUMBER	RG-C-040	REVISION					