



12/16/2020 3:26:03 PM

KEYNOTES - EXTERIOR ELEVATION

- 1 GUTTER
- 2 EXISTING CONC CURB AND STEEL ANGLE TO BE CUT AND REMOVED AT NEW DOOR LOCATION
- 3 INSULATED METAL ROOF PANEL - 5"
- 4 INSULATED METAL WALL PANEL - 3"
- 5 FASCIA
- 6 FUTURE CANOPY
- 7 NOT USED
- 8 OVERHEAD DOOR
- 9 EXPANSION JOINT AND COVER
- 11 PATCH AND REPAIR EXISTING WALL AT NEW WORK
- 12 DOWNSPOUT, SURFACE DRAIN WITH CONCRETE SPLASH BLOCK
- 13 EXISTING RETURN AIR GRILLE TO BE RELOCATED, SEE MECH.
- 14 CUT EXISTING INSULATED METAL PANEL WALL
- 15 EXISTING HOLLOW METAL DOOR, FRAME AND FLASHING TO BE REMOVED
- 16 EXISTING LIGHT TO REMAIN
- 18 RELOCATED RETURN AIR GRILLE LOCATION. ALIGN TOP TO EXISTING GRILLES.
- 19 EXTERIOR LIGHT, SEE ELECTRICAL
- 20 HVAC EQUIPMENT, SEE MECHANICAL. SEE 7/A421 FOR TYPICAL PENETRATION DETAIL.

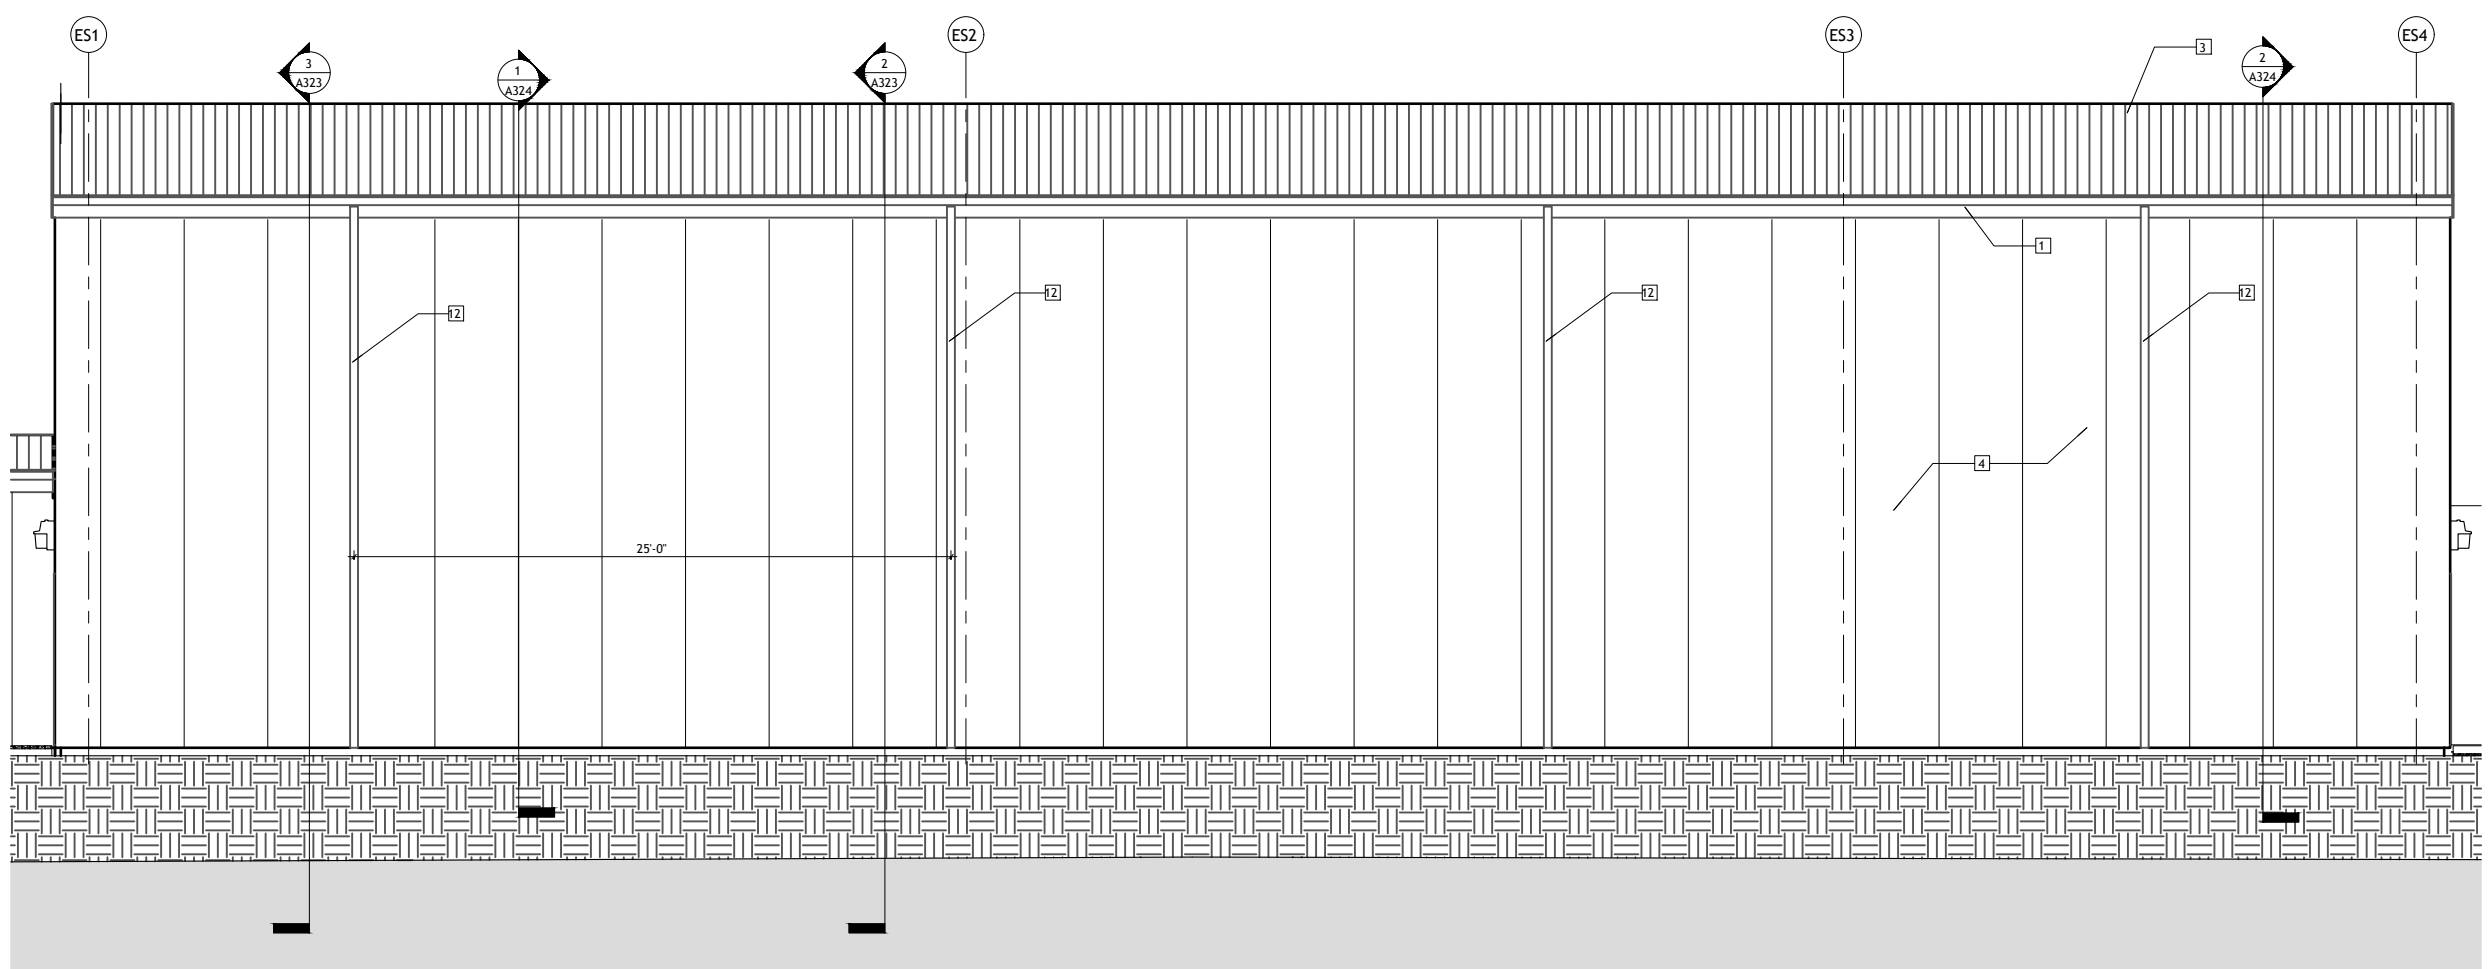

1 FCES WEST ELEVATION
A304 1/4" = 1'-0"

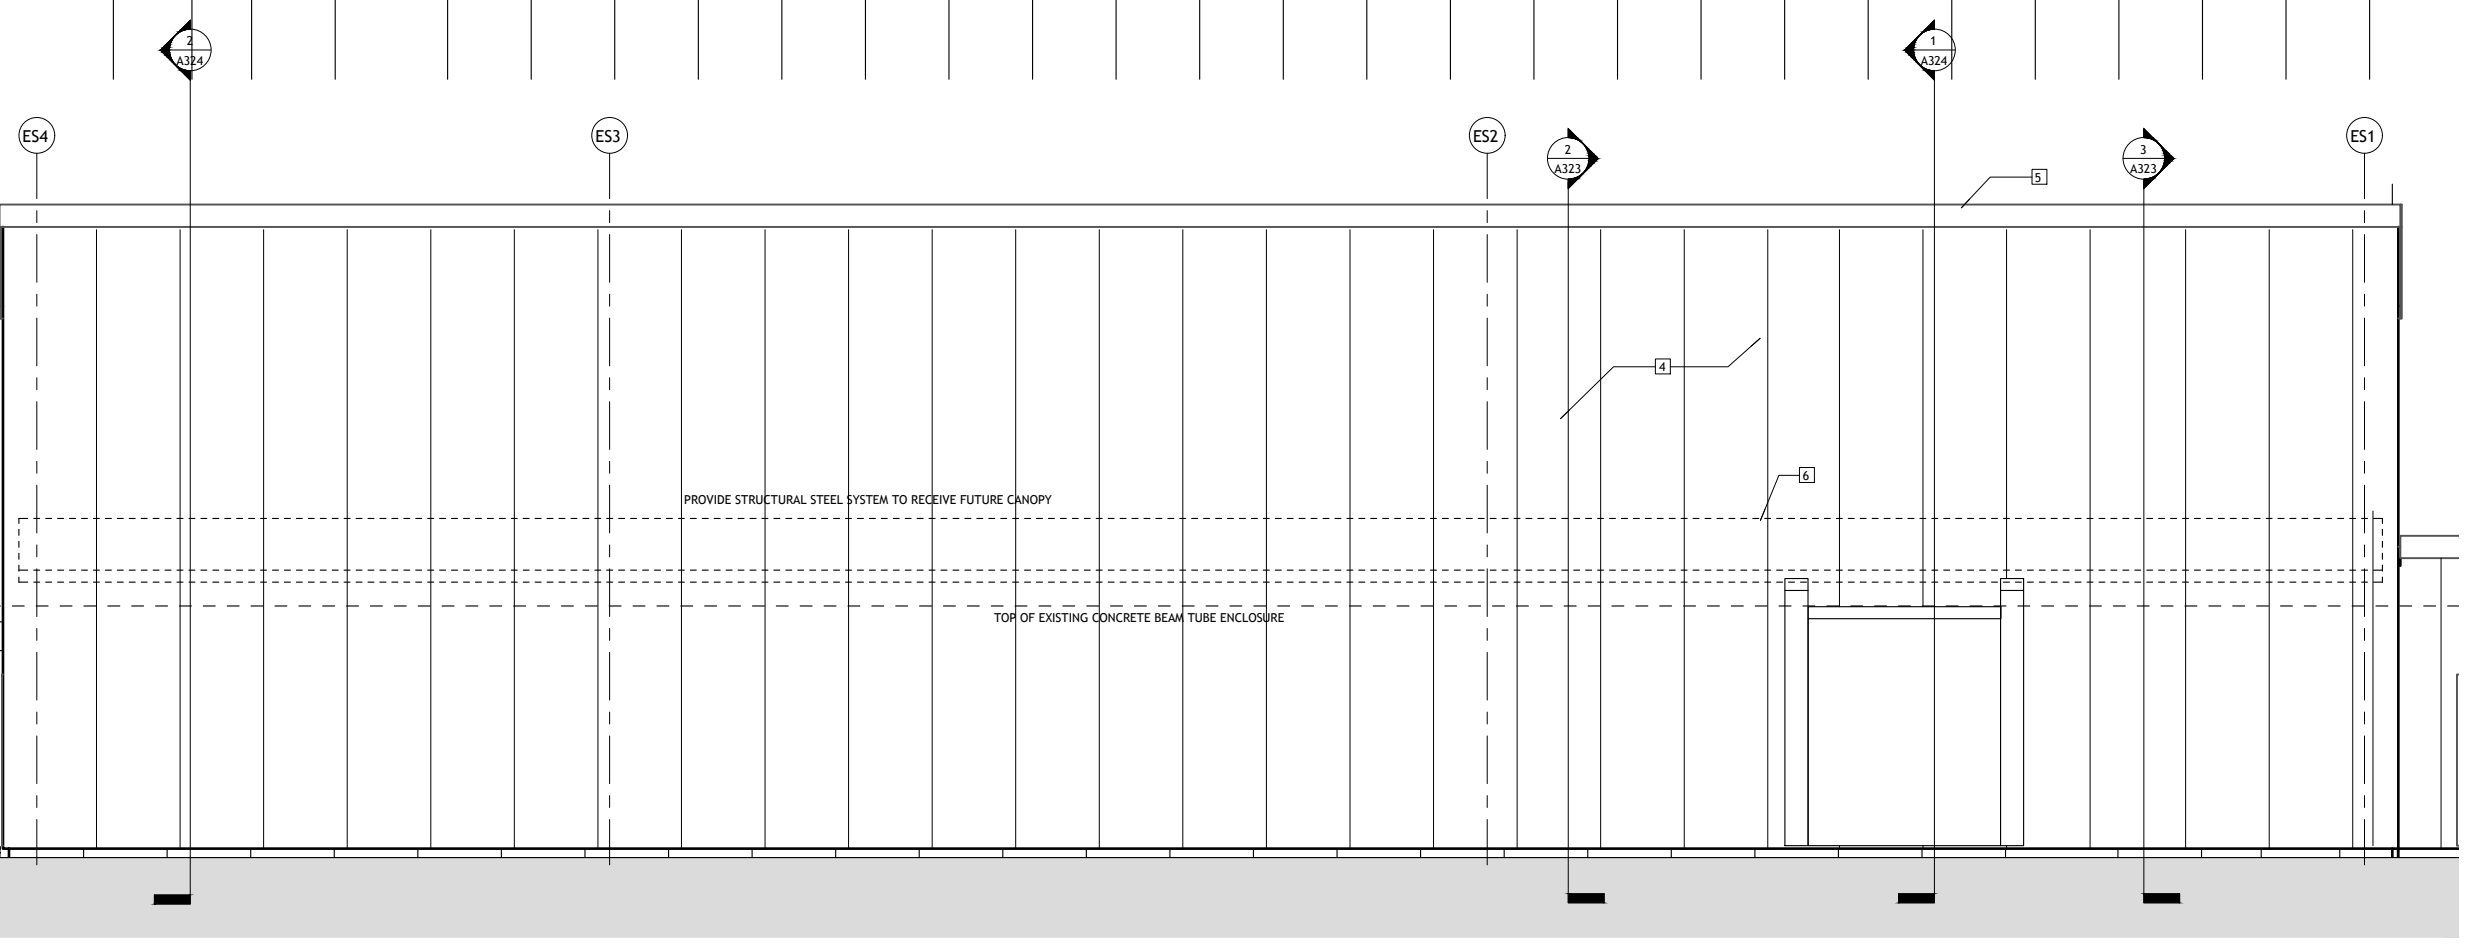

2 FCES EAST ELEVATION
A304 1/4" = 1'-0"

LIGO-D2100303-v1

DANA ENGINEERING, INC.
PROFESSIONAL SERVICE CORPORATION

4000 SOUTH IRBY STREET
KENNEWICK, WA 99337
(509) 582-0126

Revisions		
No.	Description	Date

LIGO Laboratory A+ Project
Hanford, WA

FCES ELEVATIONS

	project number	21262.00	drawing number	A304
	date	01.13.20		
	phase	CONSTRUCTION		